Appendix 1: Permit Sketches





Joint Permit Application Package Albany Port District Commission


Port of Albany Expansion Project



Port of Albany Expansion Project	Joint Permit Application Package	
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	McFarland Johnson	

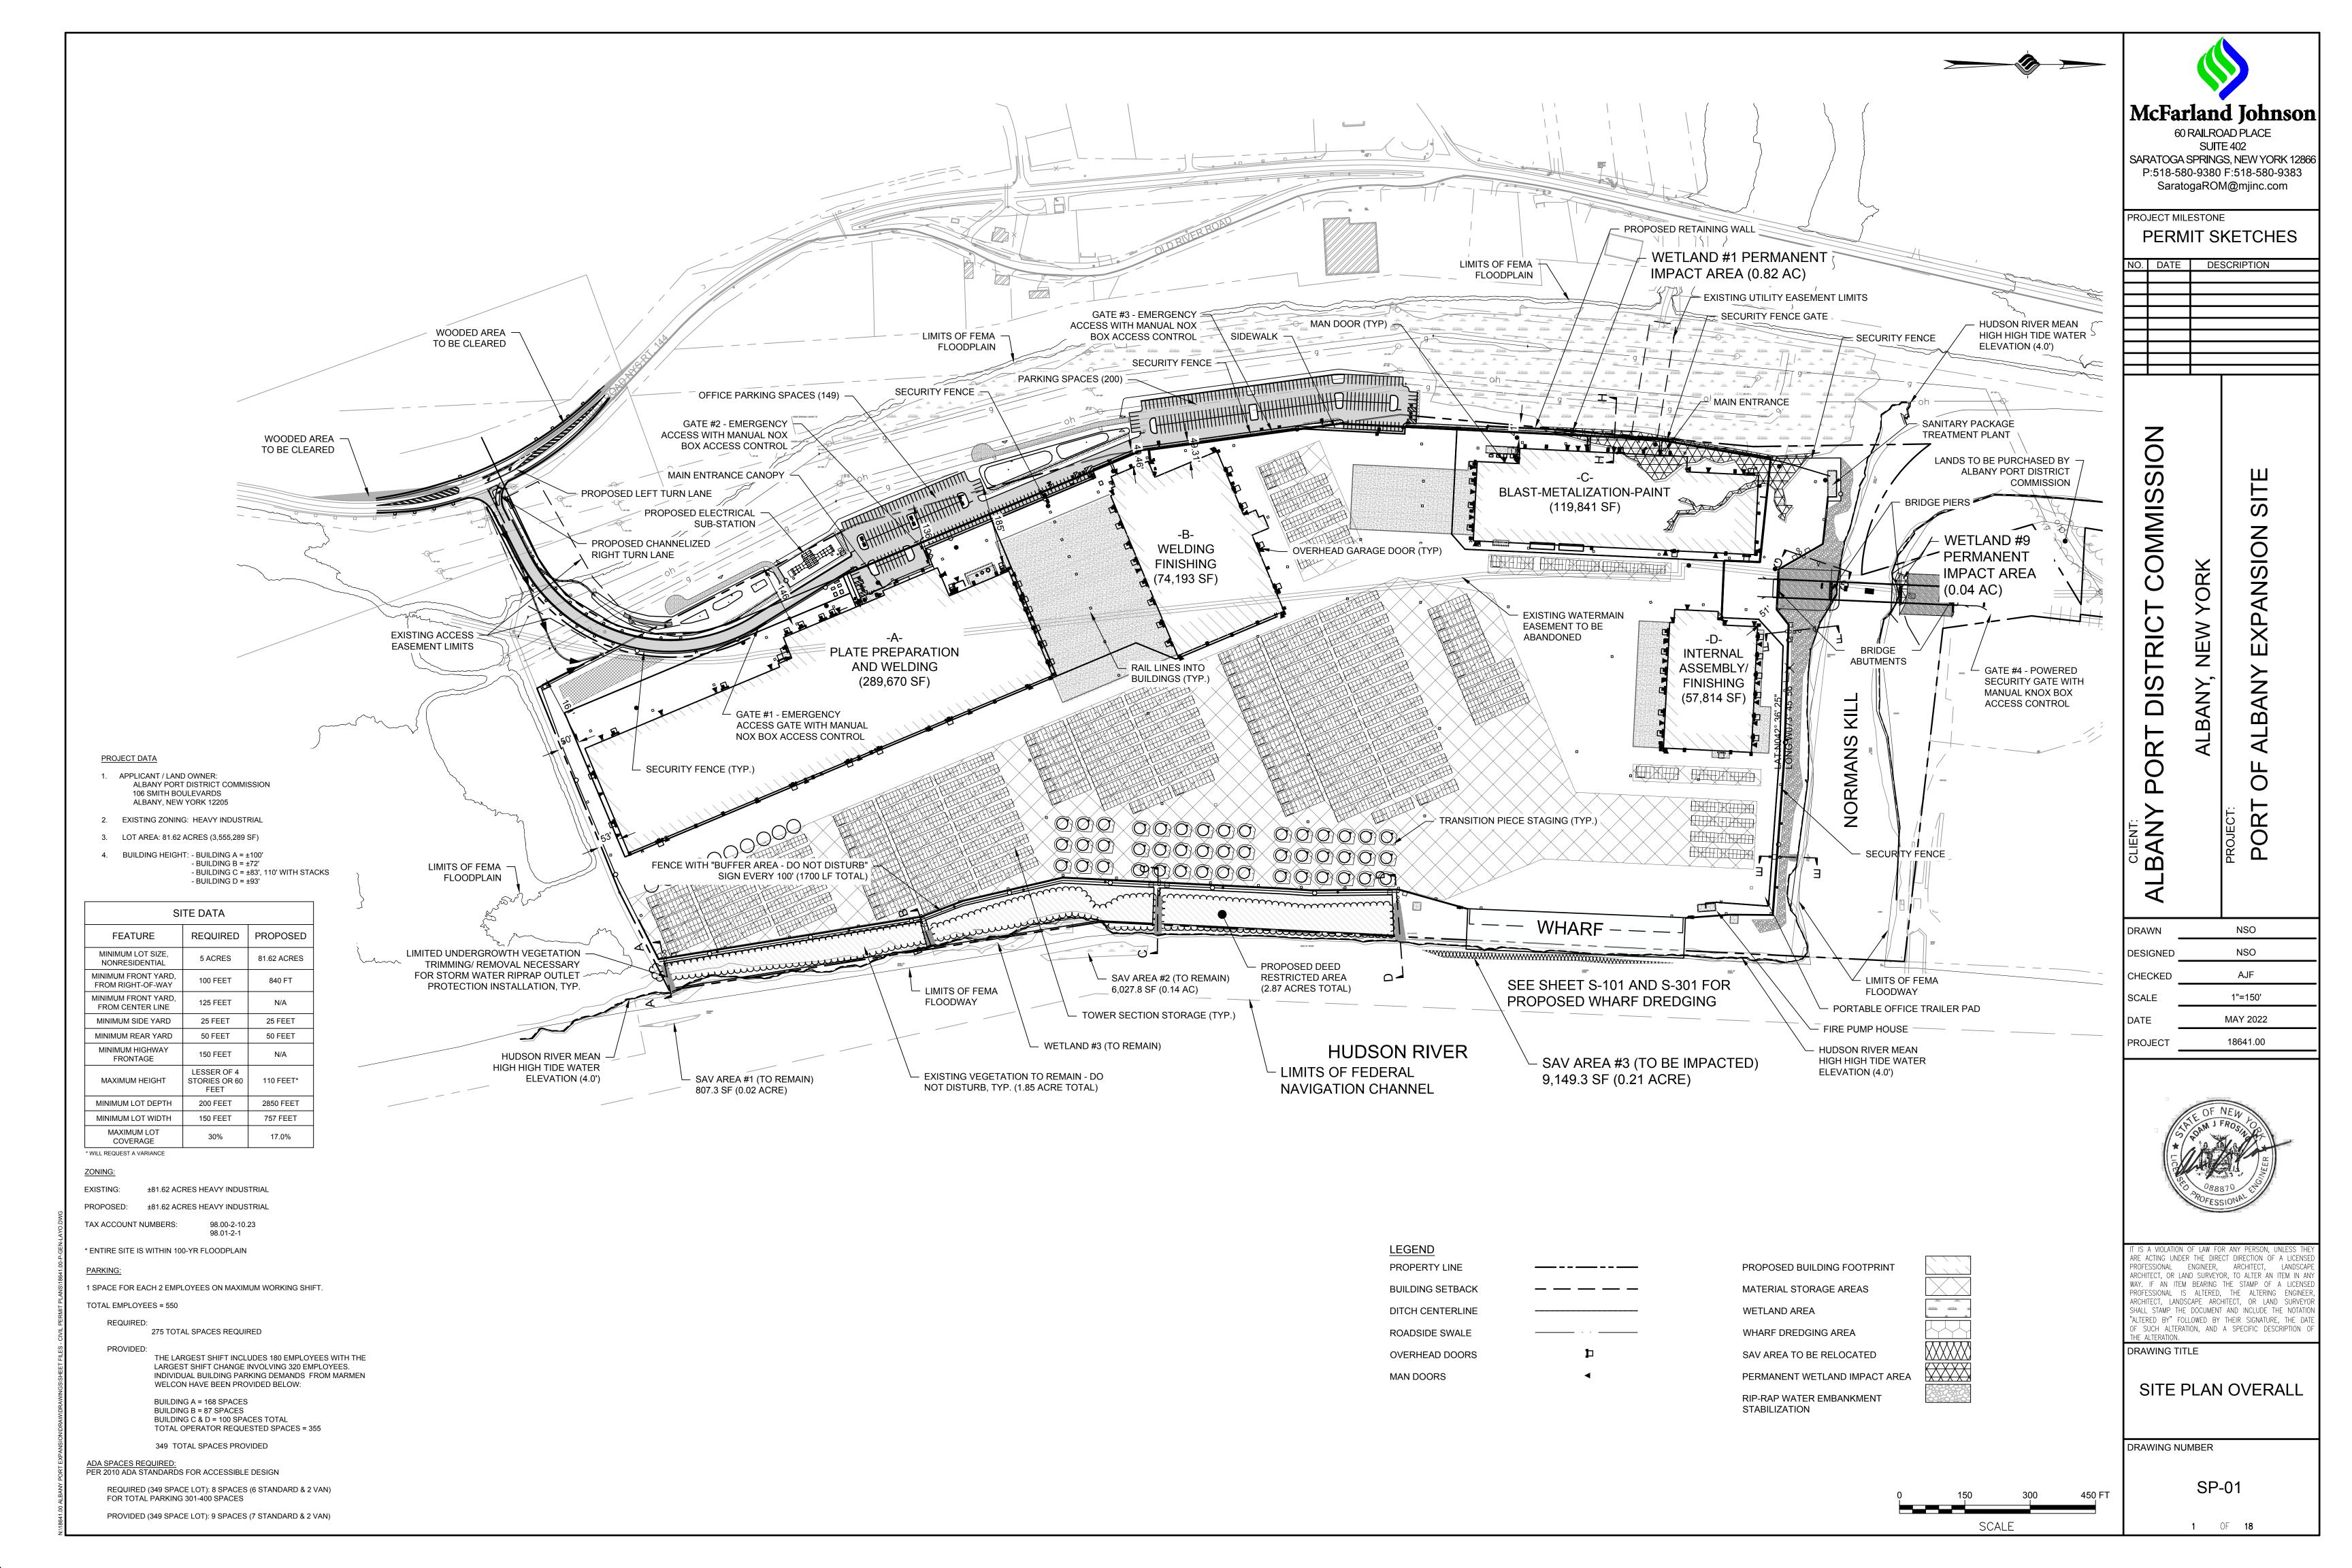

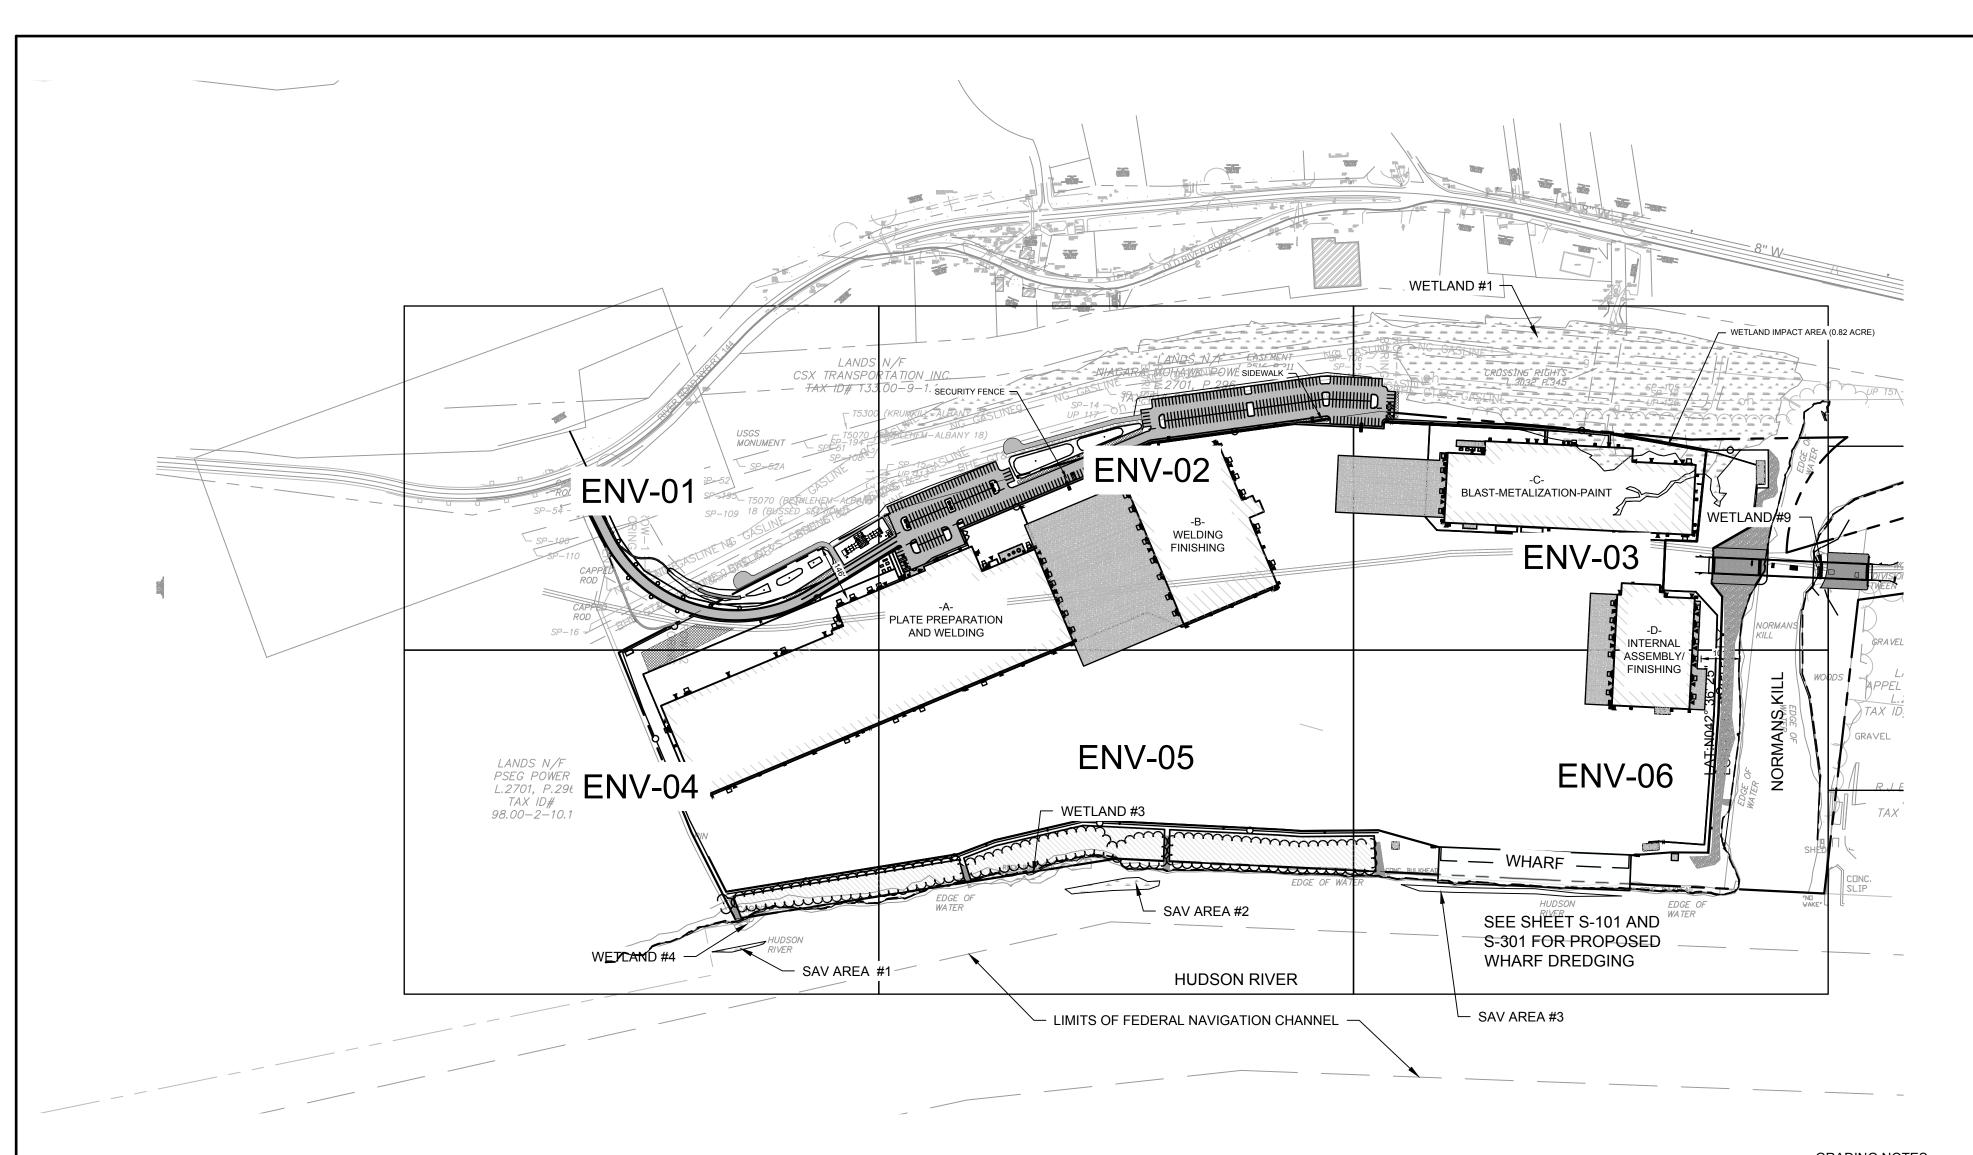

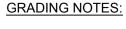

- 1. REMOVE AND STOCKPILE TOPSOIL AS DIRECTED BY THE CONSTRUCTION MANAGER. REPLACE TOPSOIL TO A MINIMUM 4" DEPTH. ALL DISTURBED AREAS TO BE HYDROSEEDED AS DIRECTED BY THE CONSTRUCTION MANAGER.
- CONTRACTOR SHALL BE RESPONSIBLE FOR THE MAINTENANCE AND REMOVAL OF TEMPORARY SEDIMENTATION CONTROLS, INCLUDING INLET PROTECTION AND SILT FENCE. EROSION CONTROL MEASURES SHALL NOT BE REMOVED BEFORE VEGETATION HAS OCCURRED COMPLETELY.
- 3. THE CONTRACTOR SHALL BE RESPONSIBLE FOR RESTORATION OF TOPSOIL TO ALL DISTURBED AREAS. IT IS THE CONTRACTOR'S RESPONSIBILITY TO MAINTAIN EROSION CONTROL MEASURES AT ALL TIMES.
- 4. EROSION CONTROL MEASURES WILL BE IMPLEMENTED IN ACCORDANCE WITH THE NEW YORK STATE DEPARTMENT OF ENVIRONMENTAL CONSERVATION, ALBANY COUNTY HEALTH DEPARTMENT, AND THE TOWN OF BETHLEHEM REQUIREMENTS.
- 5. ALL INLETS TO THE STORM SEWER SHALL HAVE STONE DROP INLET PROTECTION. THE CONTRACTOR SHALL BE RESPONSIBLE FOR MAINTAINING BEST MANAGEMENT PRACTICES (BMP'S) UNTIL GROUND COVER IS ESTABLISHED.
- 6. SILT FENCE, JUTE MESH, AND/OR EROSION CONTROL BLANKETS WILL BE USED ON STEEP SLOPES AND WHEREVER NECESSARY TO CONTROL EROSION AND SILTATION OF EXISTING DRAINAGE SYSTEMS AS ORDERED BY THE ENGINEER OR SPECIFIED ON PLANS.
- 8. THE CONTRACTOR SHALL DESIGNATE A MEMBER OF HIS/HER FIRM TO BE RESPONSIBLE TO MONITOR EROSION CONTROL, EROSION CONTROL STRUCTURES, TREE PROTECTION AND PRESERVATION THROUGHOUT CONSTRUCTION.
- 9. ALL GRADING AND EARTHWORK SHALL BE IN CONFORMANCE WITH NEW YORK STATE STANDARD SPECIFICATIONS SECTION 203 EXCAVATION AND EMBANKMENT, WHICH INCLUDES MAXIMUM EMBANKMENT LIFT THICKNESS ALLOWED BASED ON THE COMPACTION EQUIPMENT USED.
- 10. ALL PROPOSED ELEVATIONS SHOWN HEREON ARE FINISHED GRADE ELEVATION.
- 11. CONTRACTOR SHALL BE RESPONSIBLE FOR VERIFYING RIM ELEVATIONS IN RELATION TO PROPOSED GRADE PRIOR TO INSTALLATION.

STORM SEWER:

1. ALL HDPE PIPES SHALL FOLLOW NYSDOT SECTION 603-2 AND 706-12, BE SMOOTH INTERIOR.

- 2. PLACE RIP-RAP AROUND ALL END SECTIONS.
- 3. IN INSTANCES WHERE THE STORM SEWER CROSSES THE SANITARY SEWER A CRUSHED STONE ENCASEMENT SHALL BE PROVIDED AROUND THE SANITARY SEWER UP TO THE STORM SEWER-COMPACT WITH APPROVED EQUIPMENT.
- 4. ALL CATCH BASINS AND STORM MANHOLES WITHIN PAVEMENT TO BE CONSTRUCTED TO WITHSTAND HS-20 LOADING.


<u>LEGEND</u>
PROPERTY LINE
BUILDING SETBACK
EXISTING RAIL LINE
EXISTING TREE LINE
DITCH CENTERLINE
ROADSIDE SWALE
WETLAND AREA

McFarland Johnson
60 RAILROAD PLACE
SUITE 402
SARATOGA SPRINGS, NEW YORK 12866
P:518-580-9380 F:518-580-9383
SaratogaROM@mjinc.com

PROJECT MILESTONE
PERMIT SKETCHES

NO.	DATE	DESCRIPTION

ALBANY PORT DISTRICT COMMISSION
ALBANY, NEW YORK
PROJECT:
PROJECT:
PORT OF ALBANY EXPANSION SITE

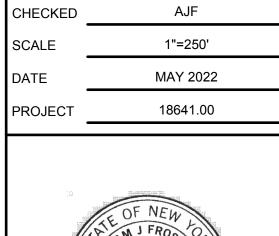

JES

NSO

IT IS A VIOLATION OF LAW FOR ANY PERSON, UNLESS THE ARE ACTING UNDER THE DIRECT DIRECTION OF A LICENSE PROFESSIONAL ENGINEER, ARCHITECT, LANDSCAP ARCHITECT, OR LAND SURVEYOR, TO ALTER AN ITEM IN AN ANALYSE OF A LICENSE OF THE OFFICE OFFICE

IT IS A VIOLATION OF LAW FOR ANY PERSON, UNLESS THEY ARE ACTING UNDER THE DIRECT DIRECTION OF A LICENSED PROFESSIONAL ENGINEER, ARCHITECT, LANDSCAPE ARCHITECT, OR LAND SURVEYOR, TO ALTER AN ITEM IN ANY WAY. IF AN ITEM BEARING THE STAMP OF A LICENSED PROFESSIONAL IS ALTERED, THE ALTERING ENGINEER, ARCHITECT, LANDSCAPE ARCHITECT, OR LAND SURVEYOR SHALL STAMP THE DOCUMENT AND INCLUDE THE NOTATION "ALTERED BY" FOLLOWED BY THEIR SIGNATURE, THE DATE OF SUCH ALTERATION, AND A SPECIFIC DESCRIPTION OF THE ALTERATION.

DRAWING TITLE

DRAWN


DESIGNED

ENVIRONMENTAL PLAN NOTES & INDEX


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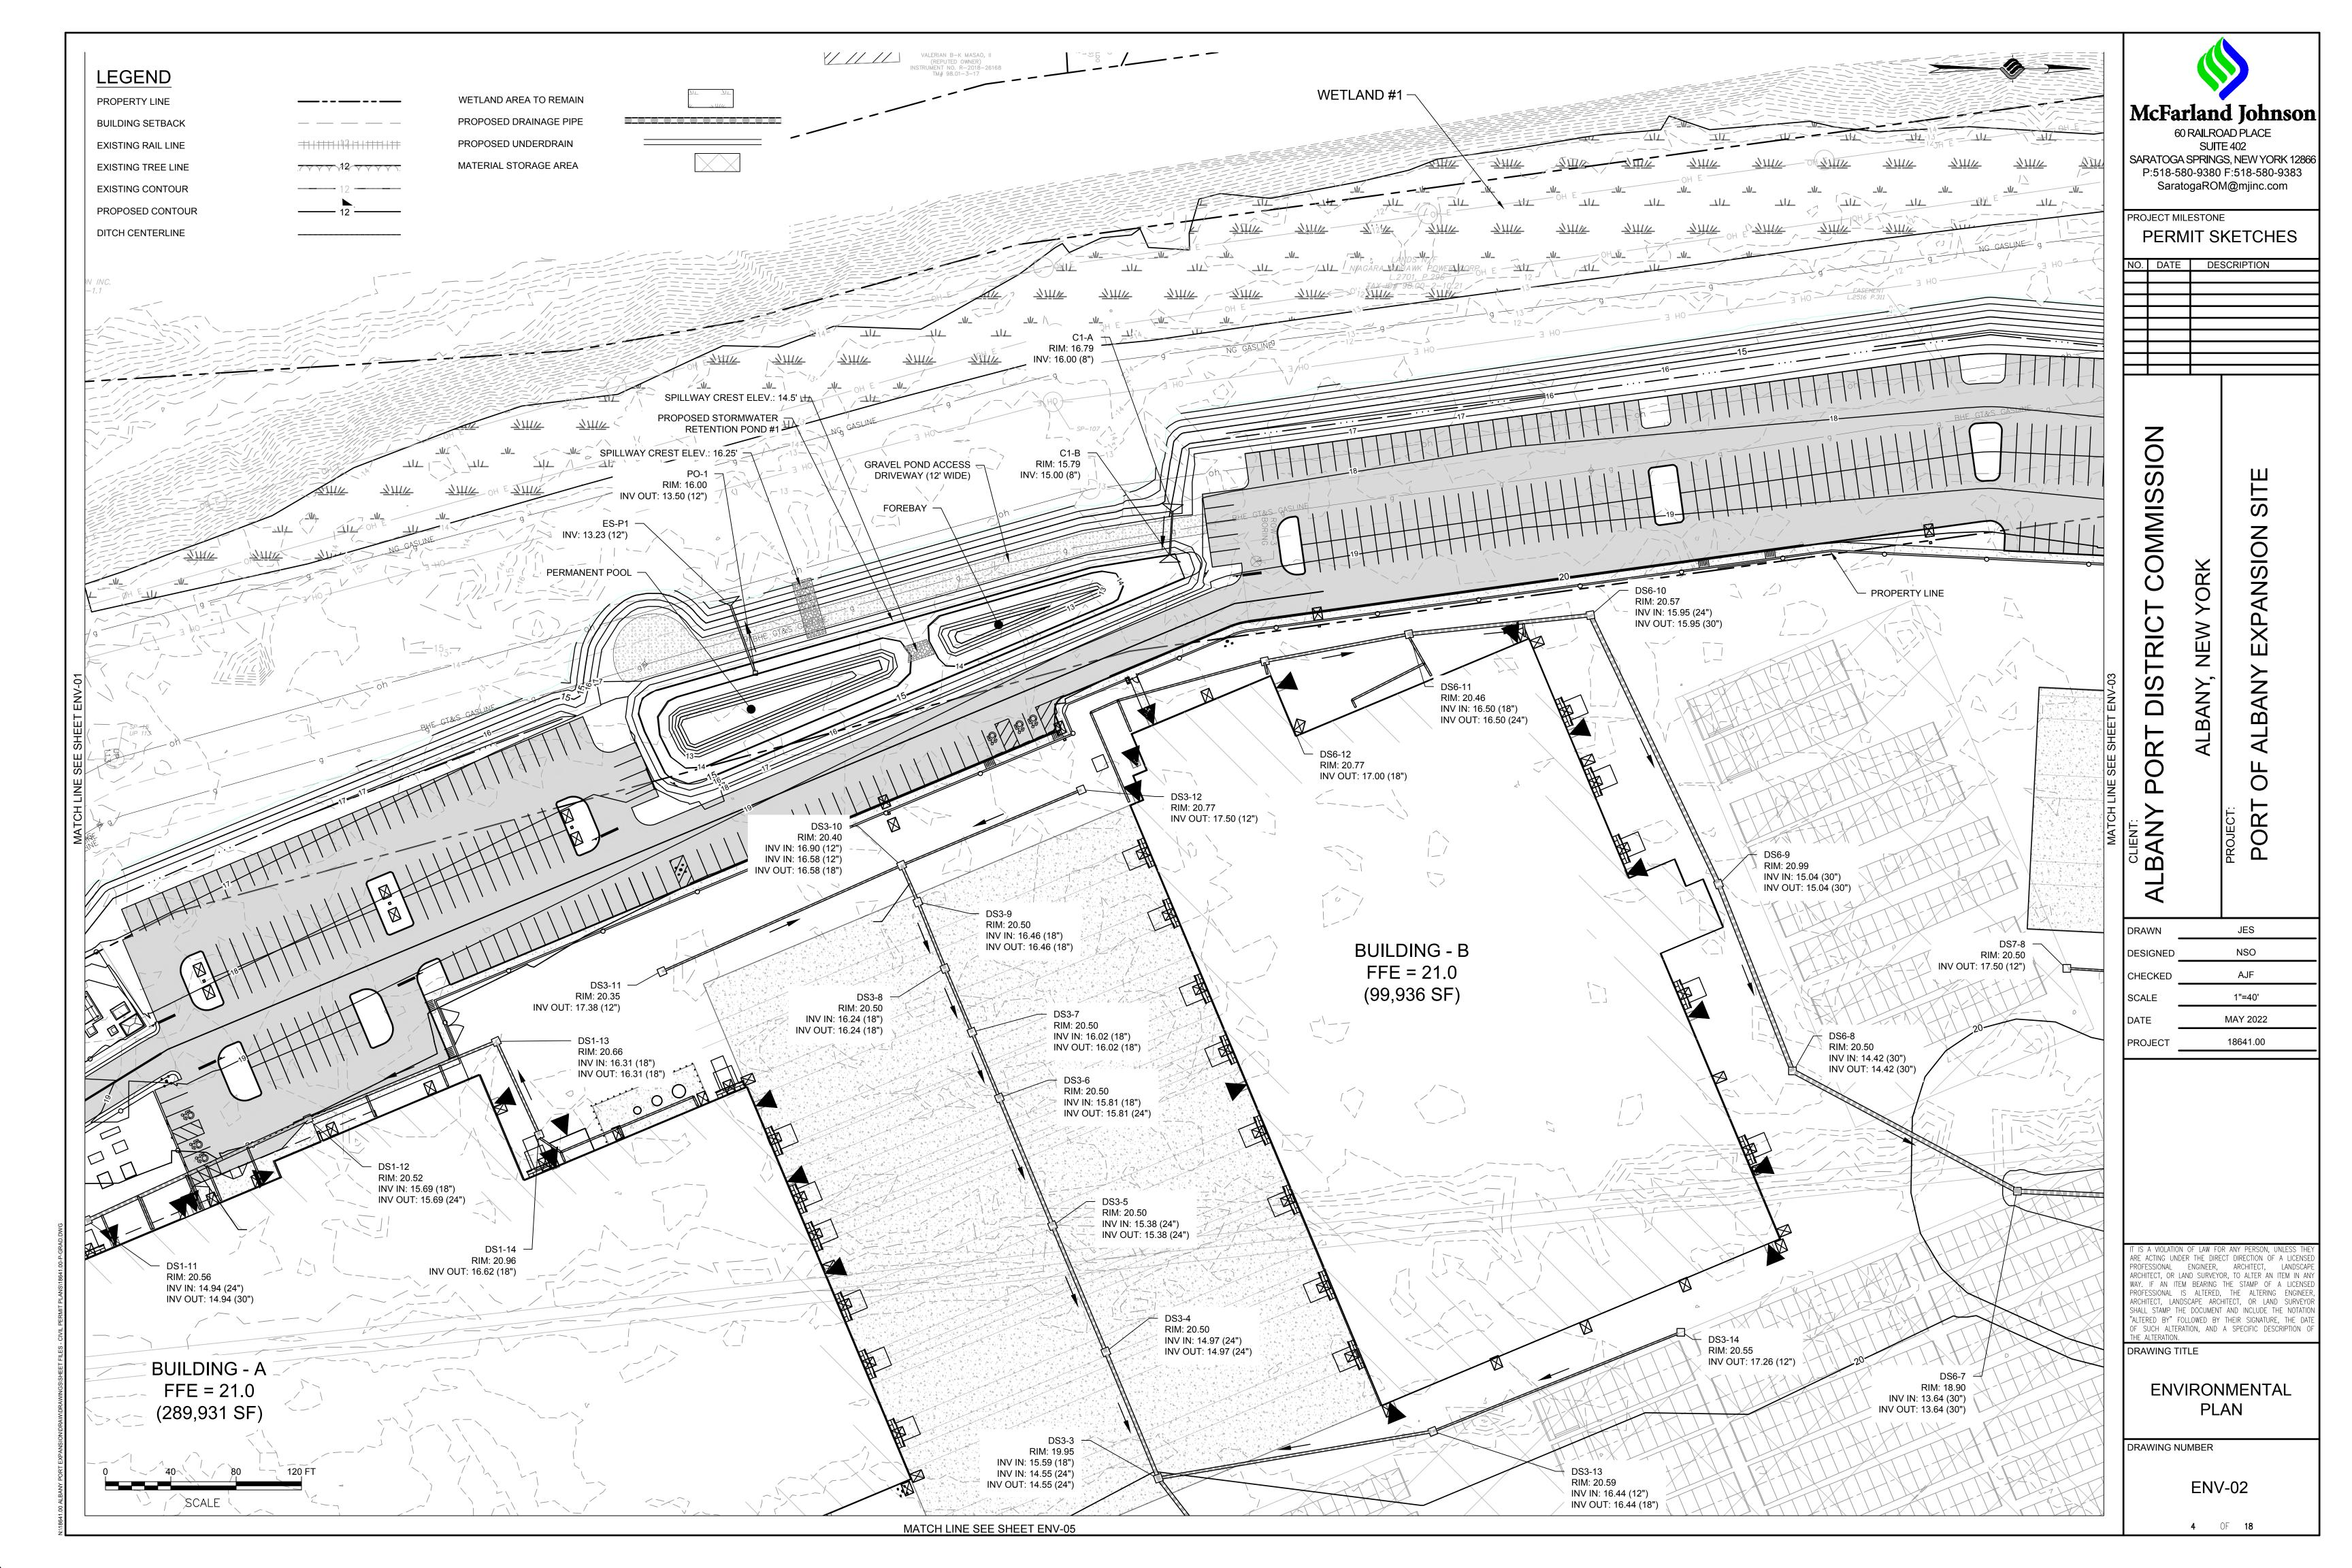
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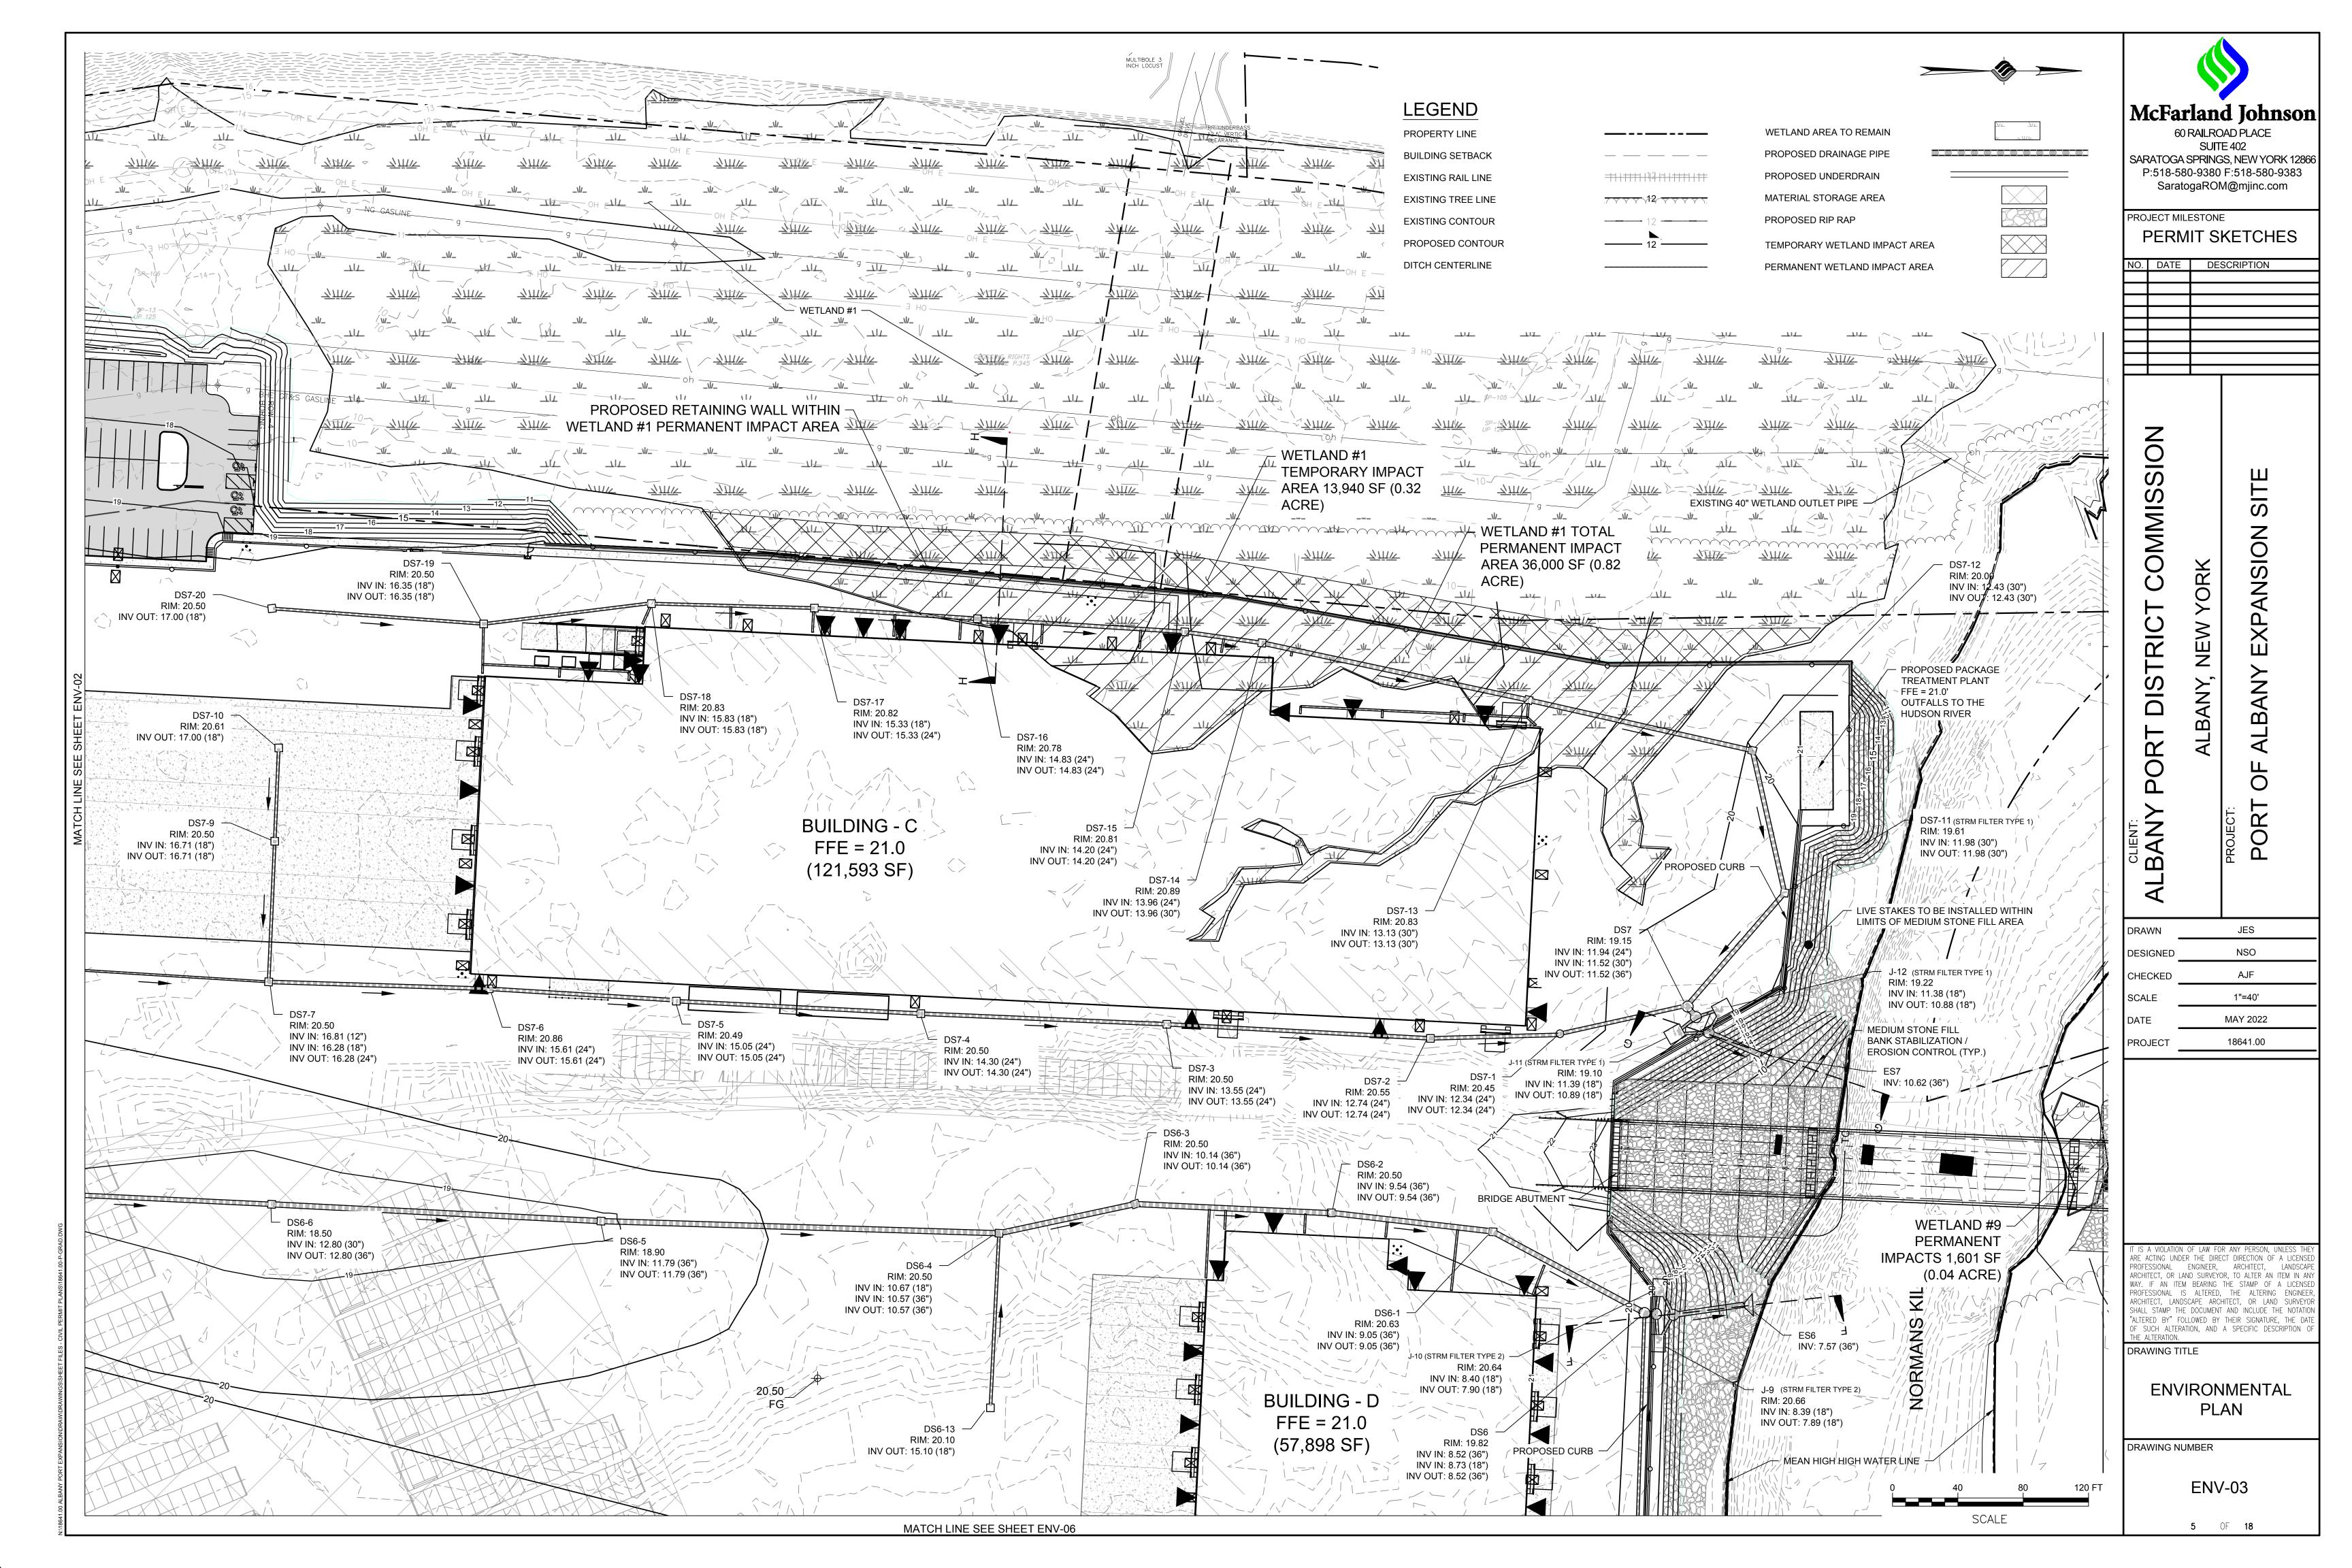
2 OF **18**





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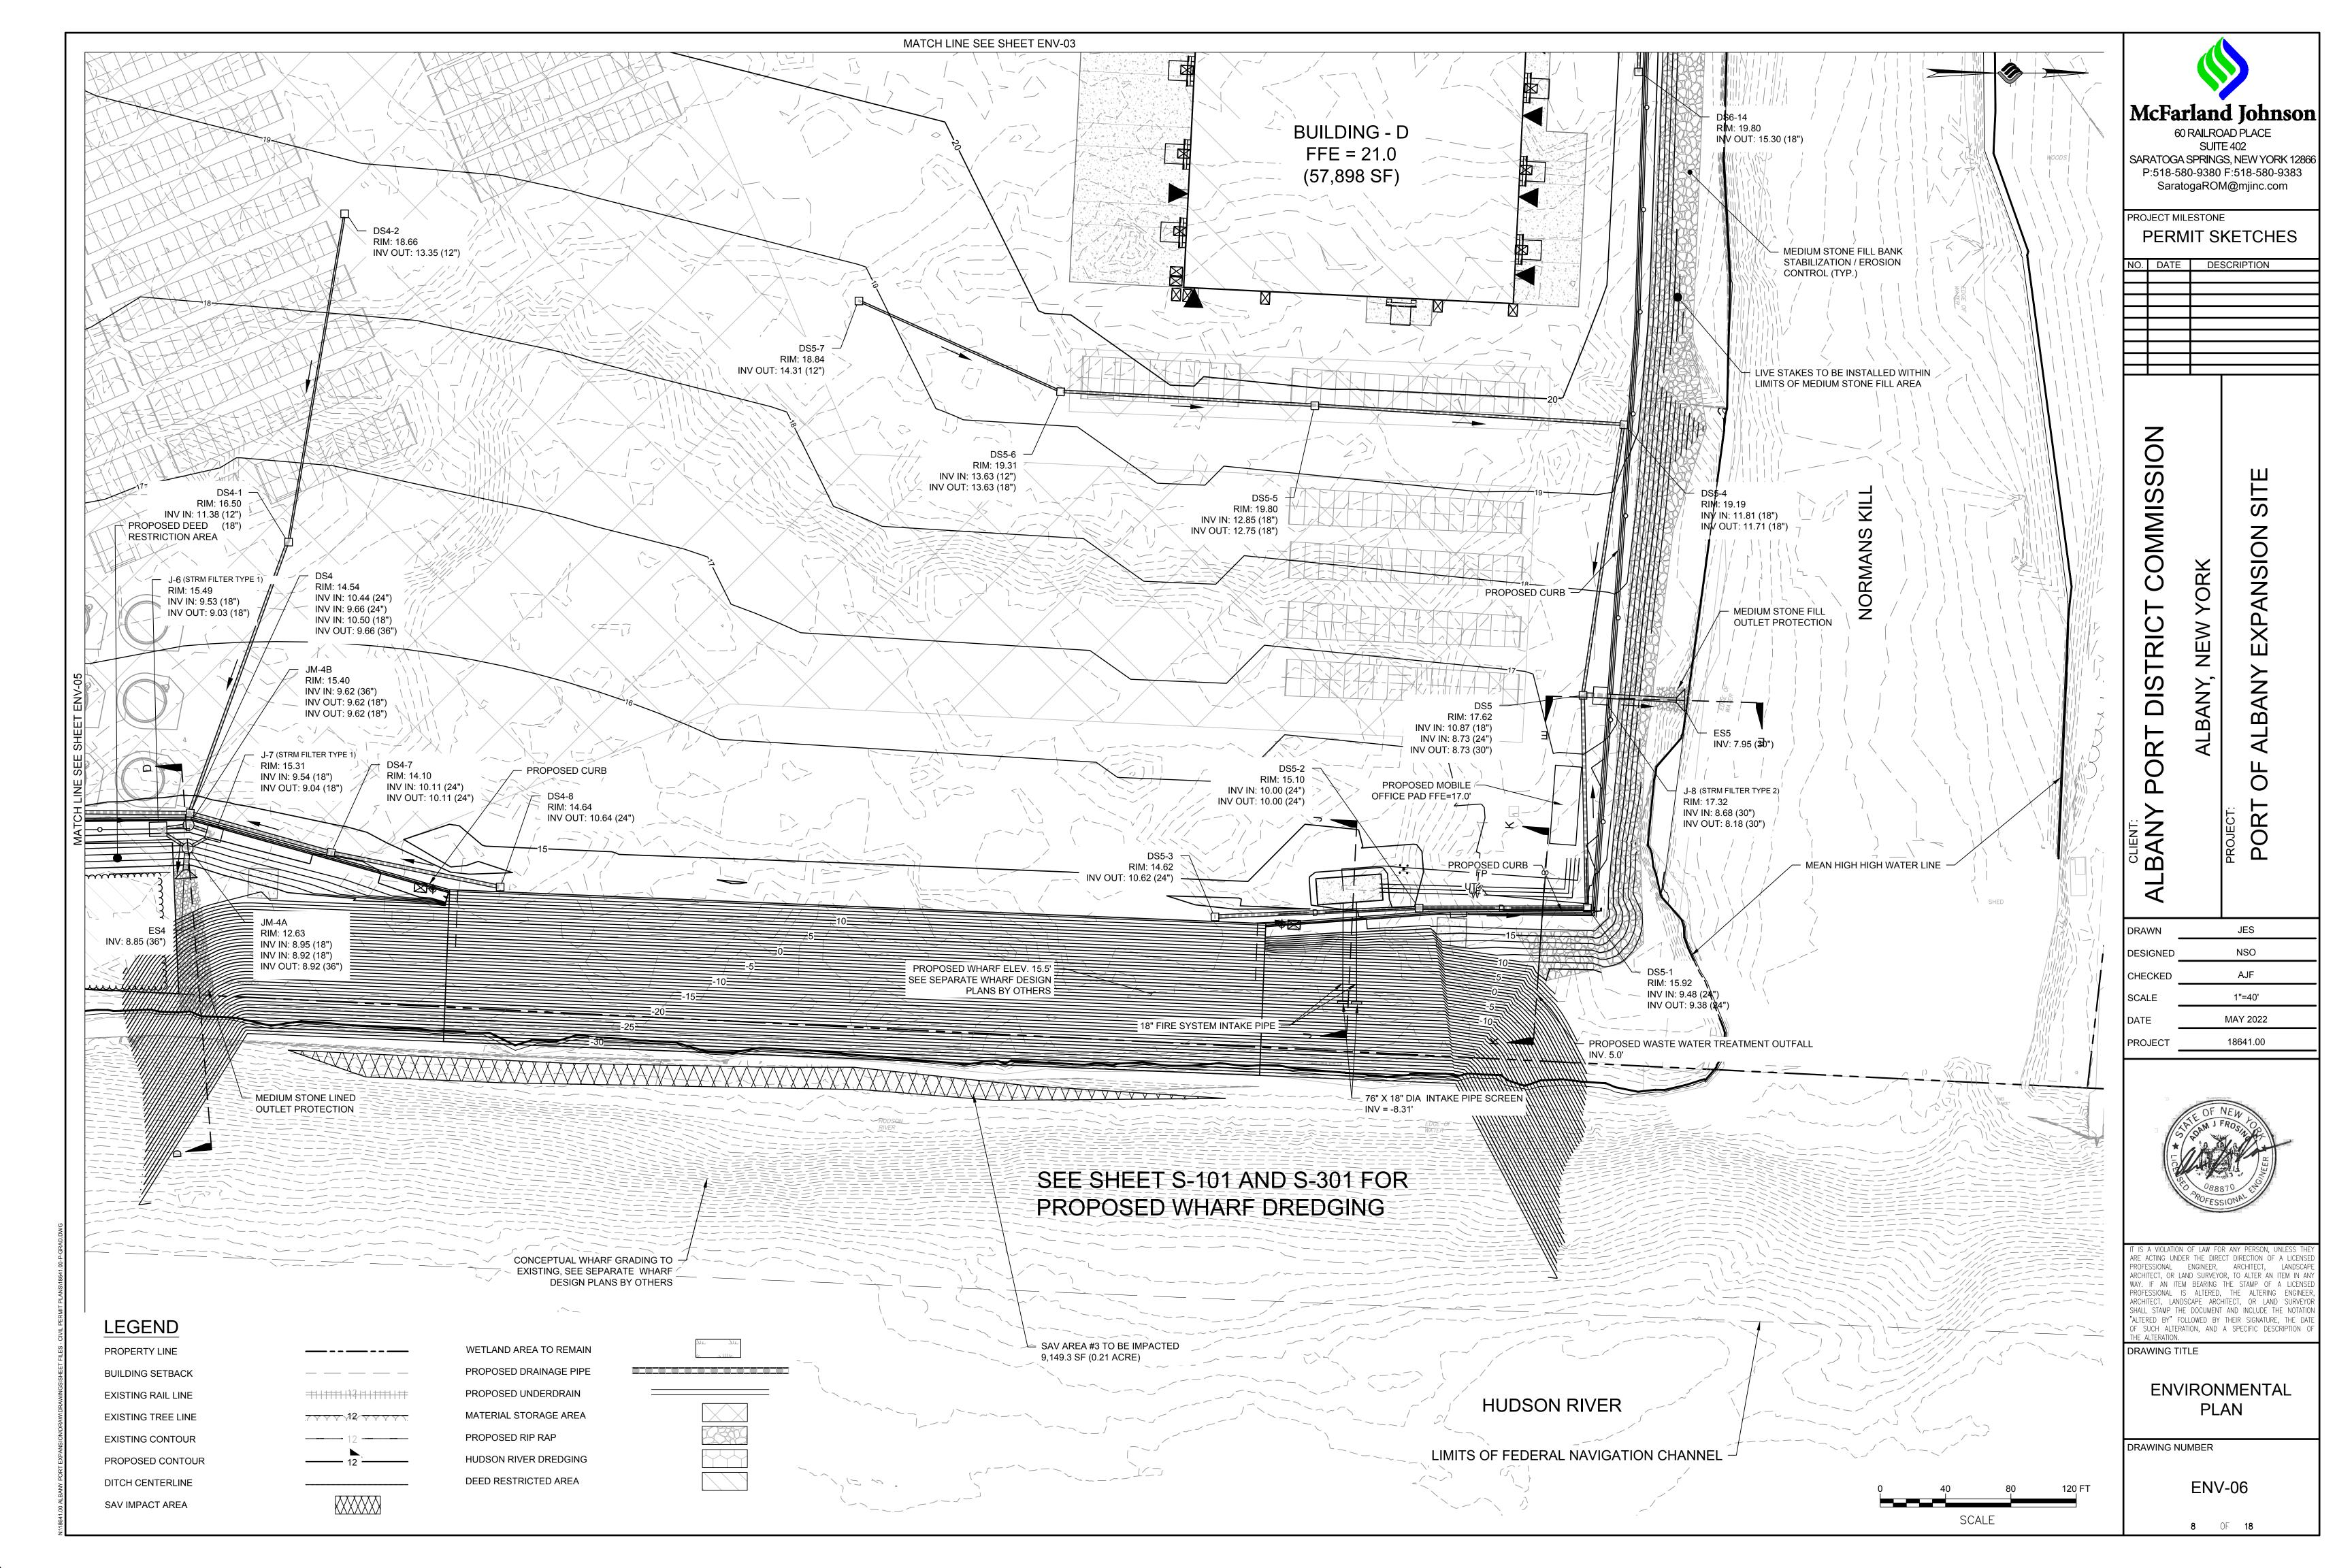


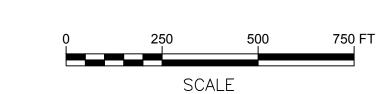





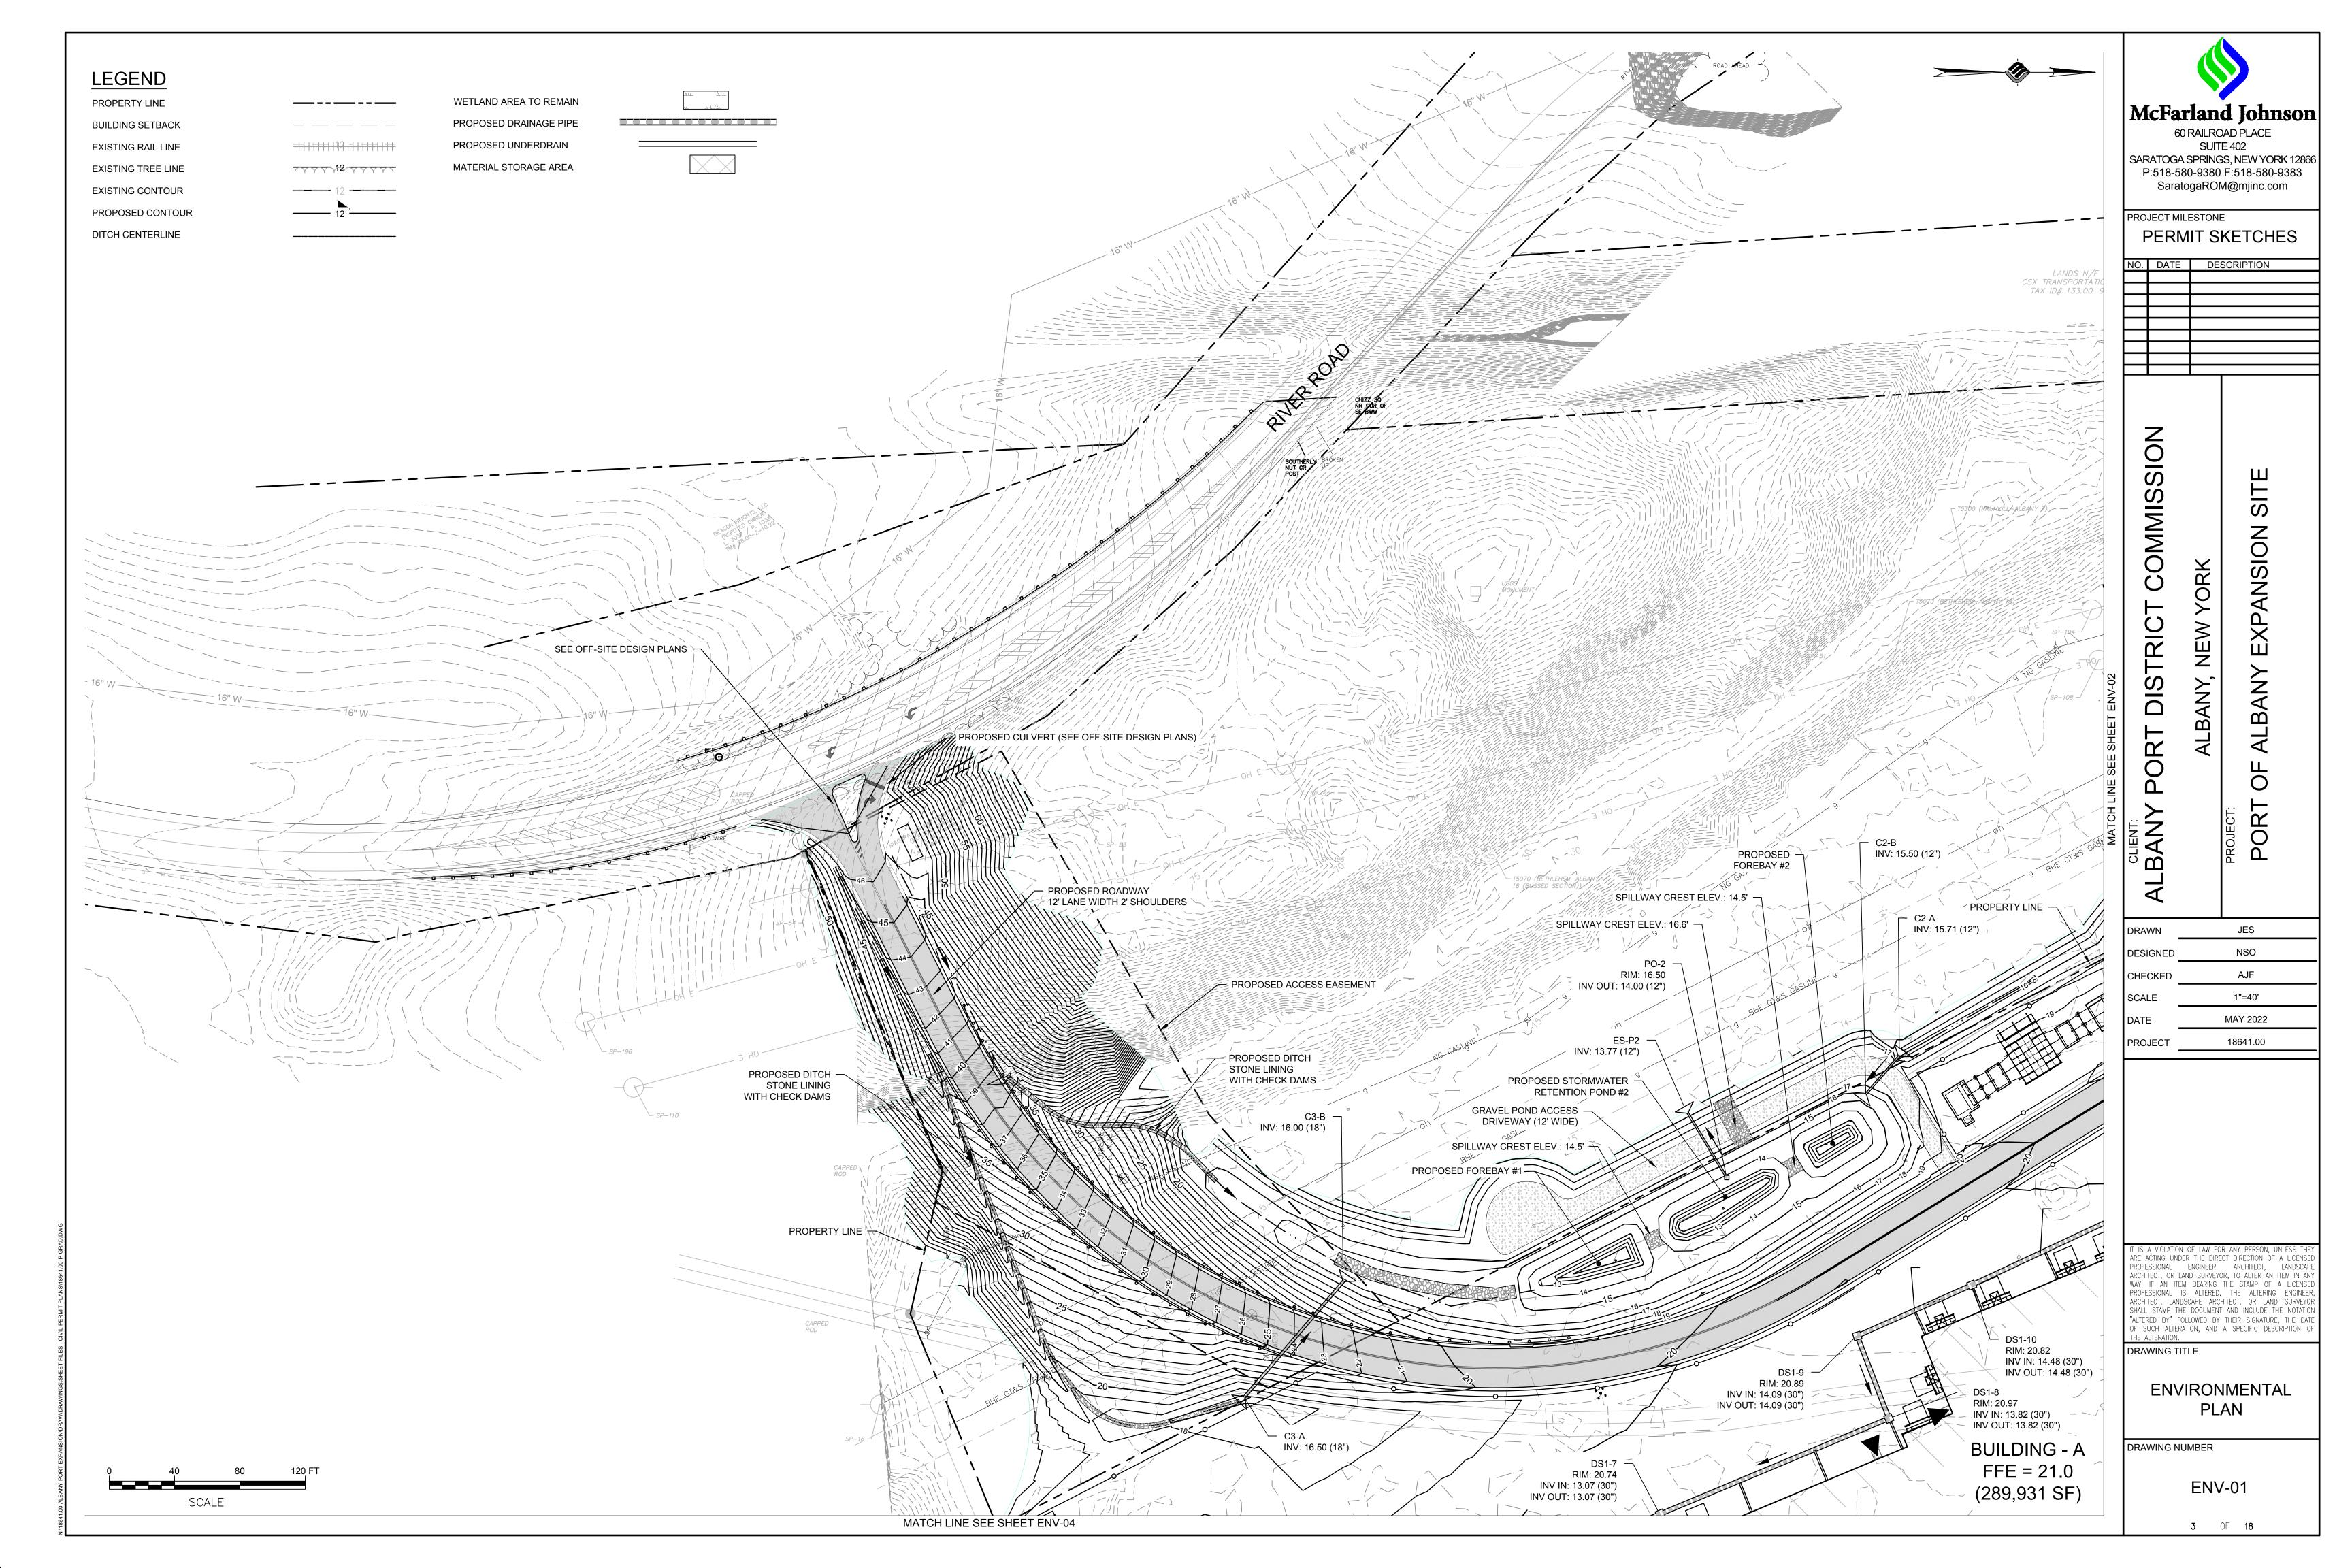

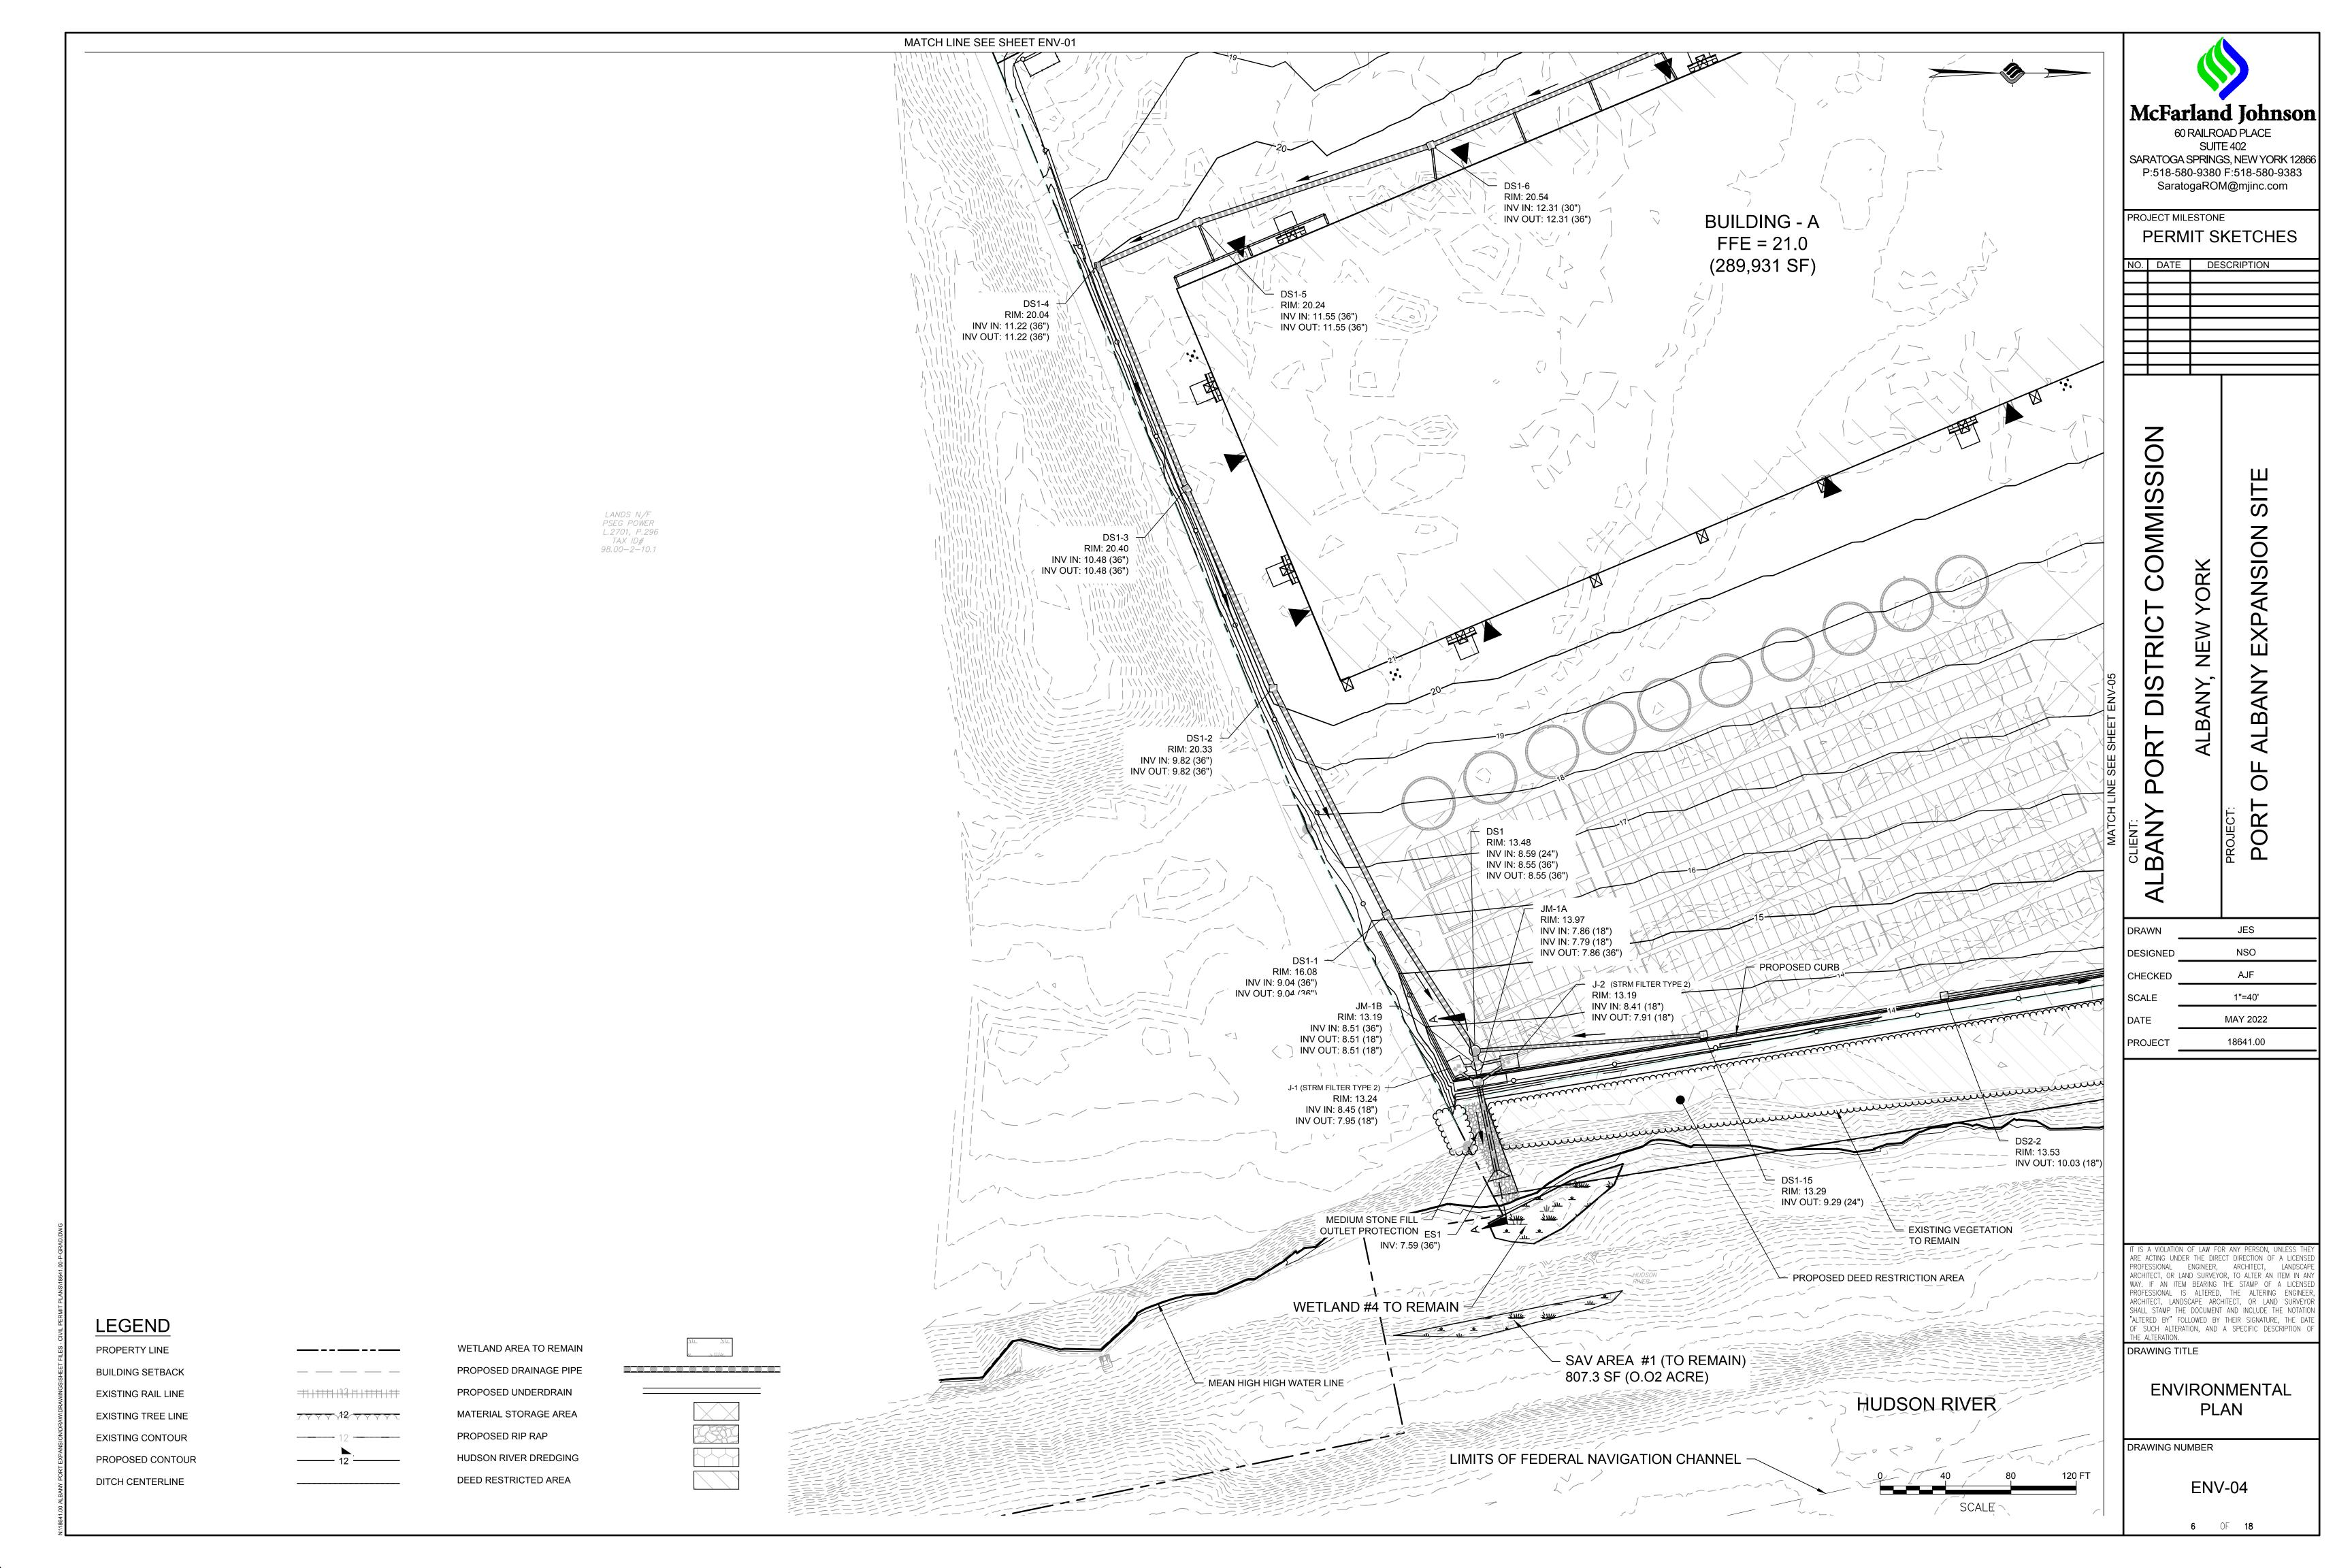


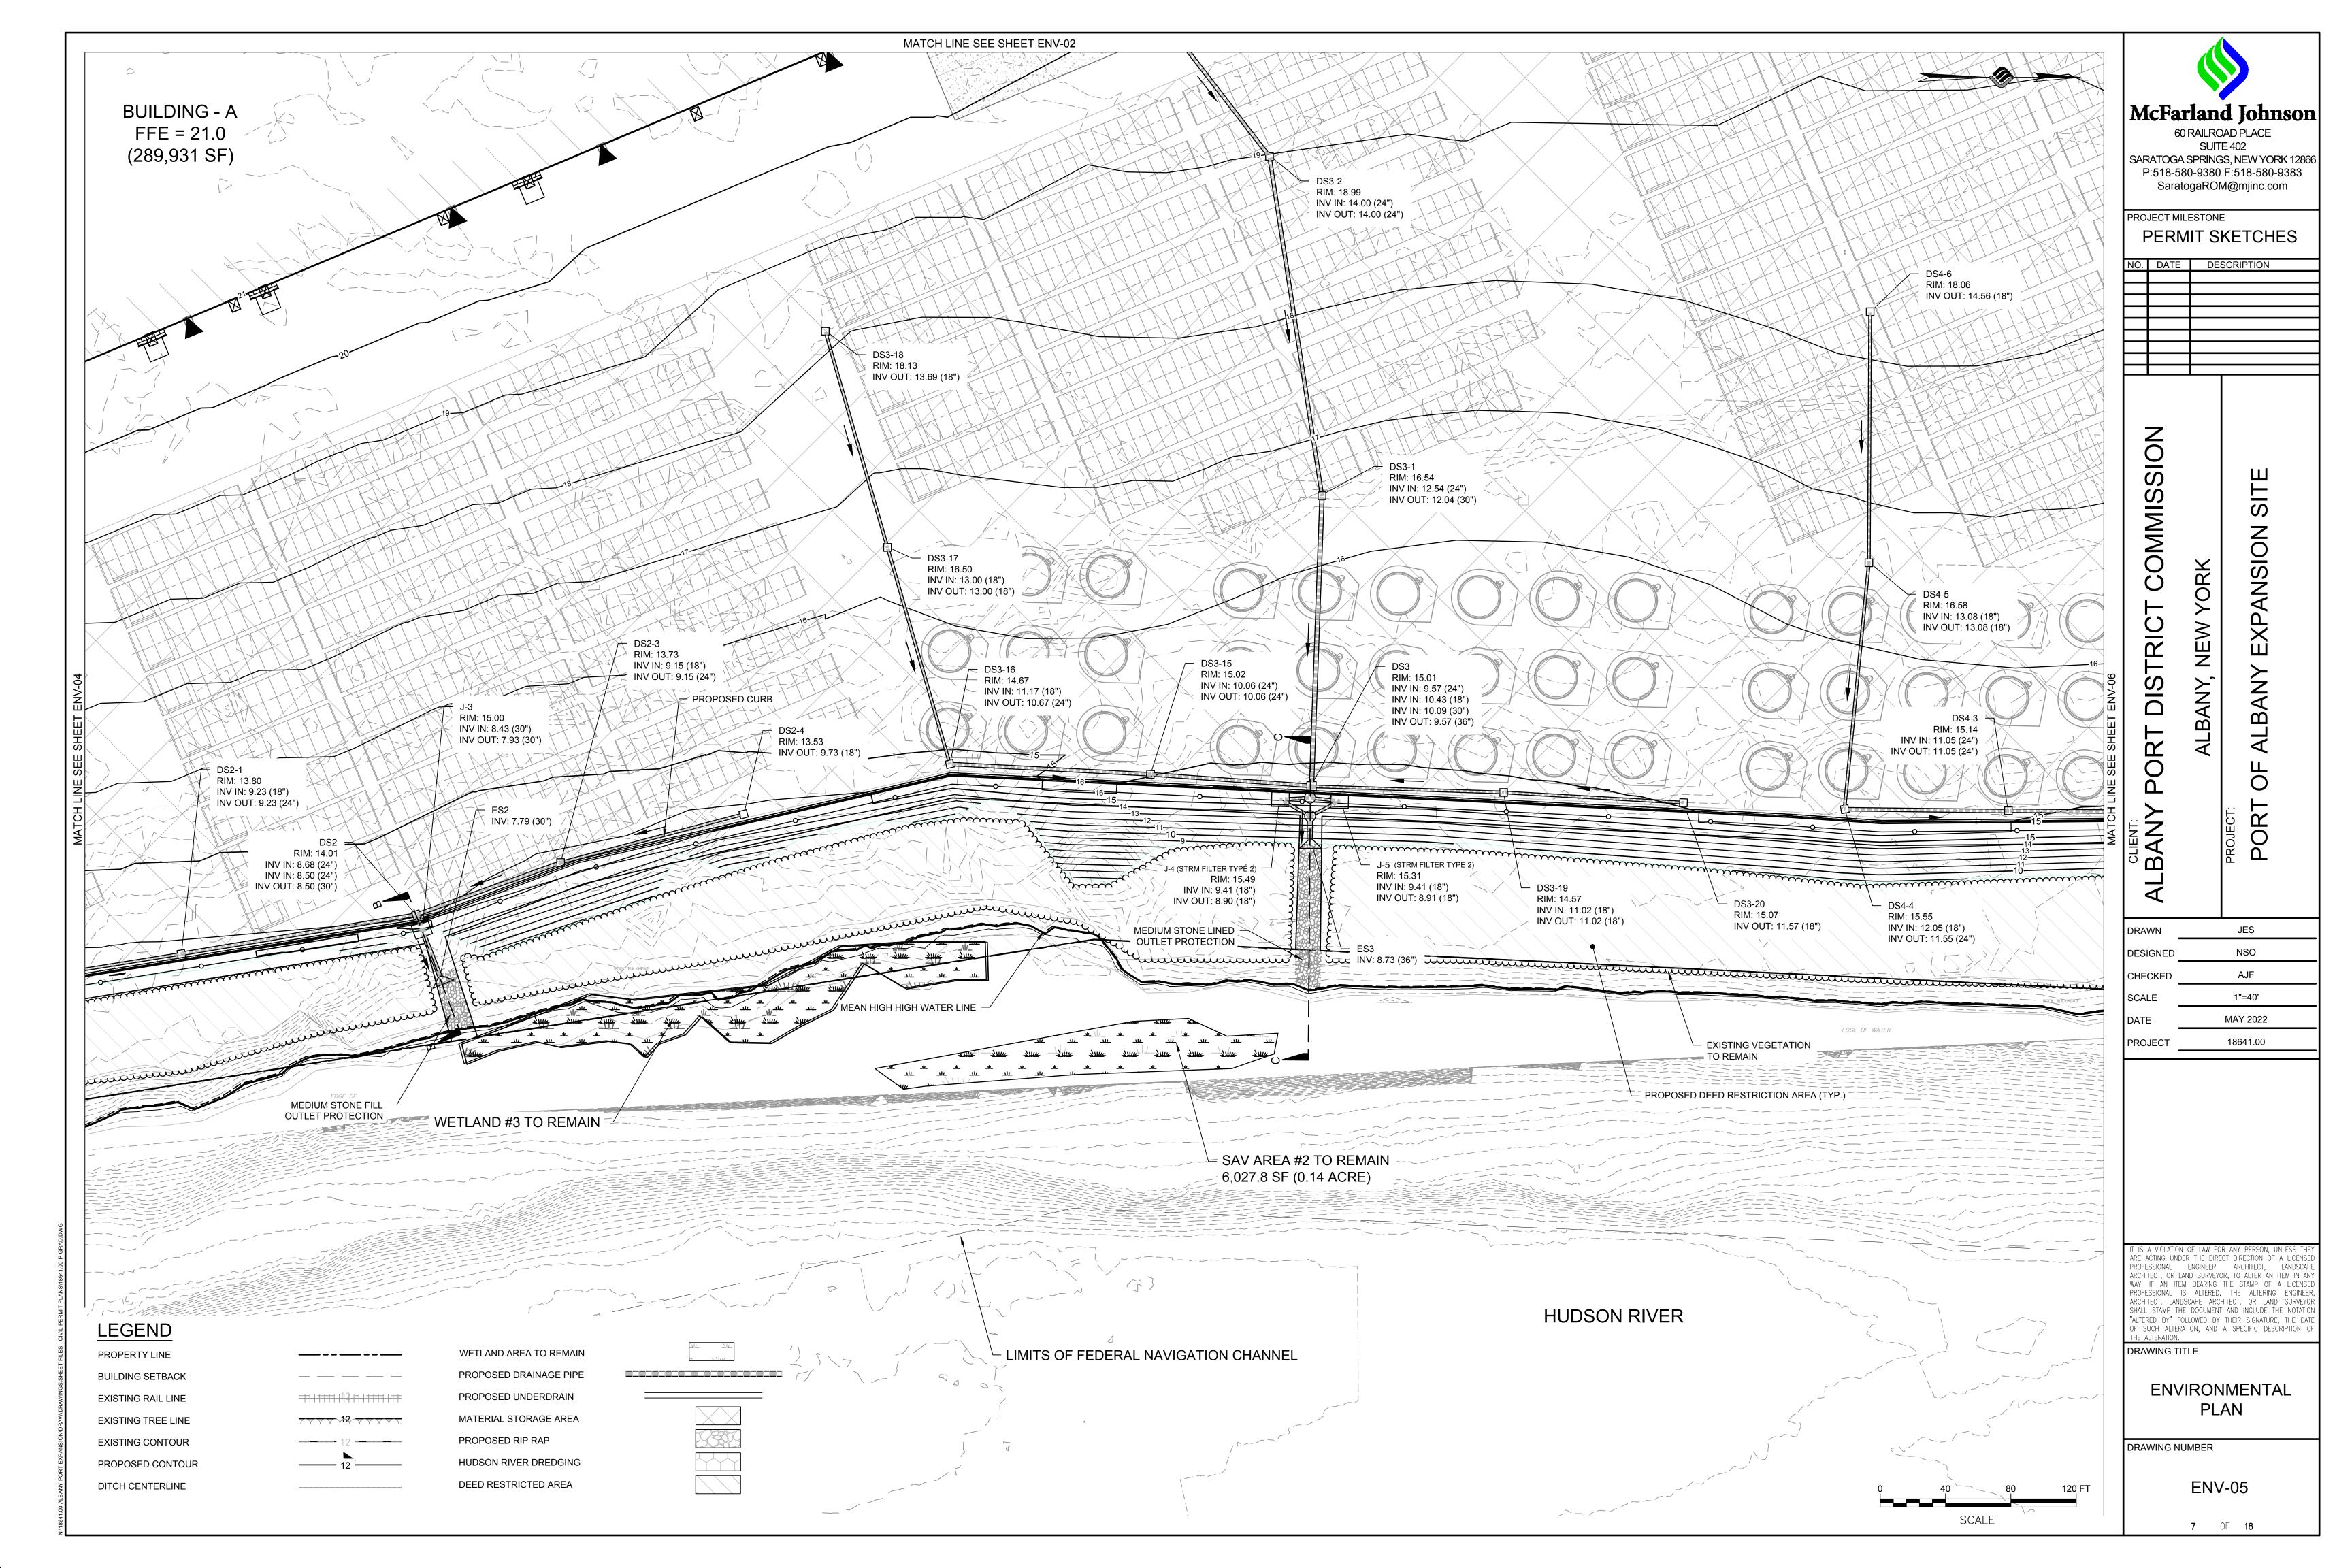

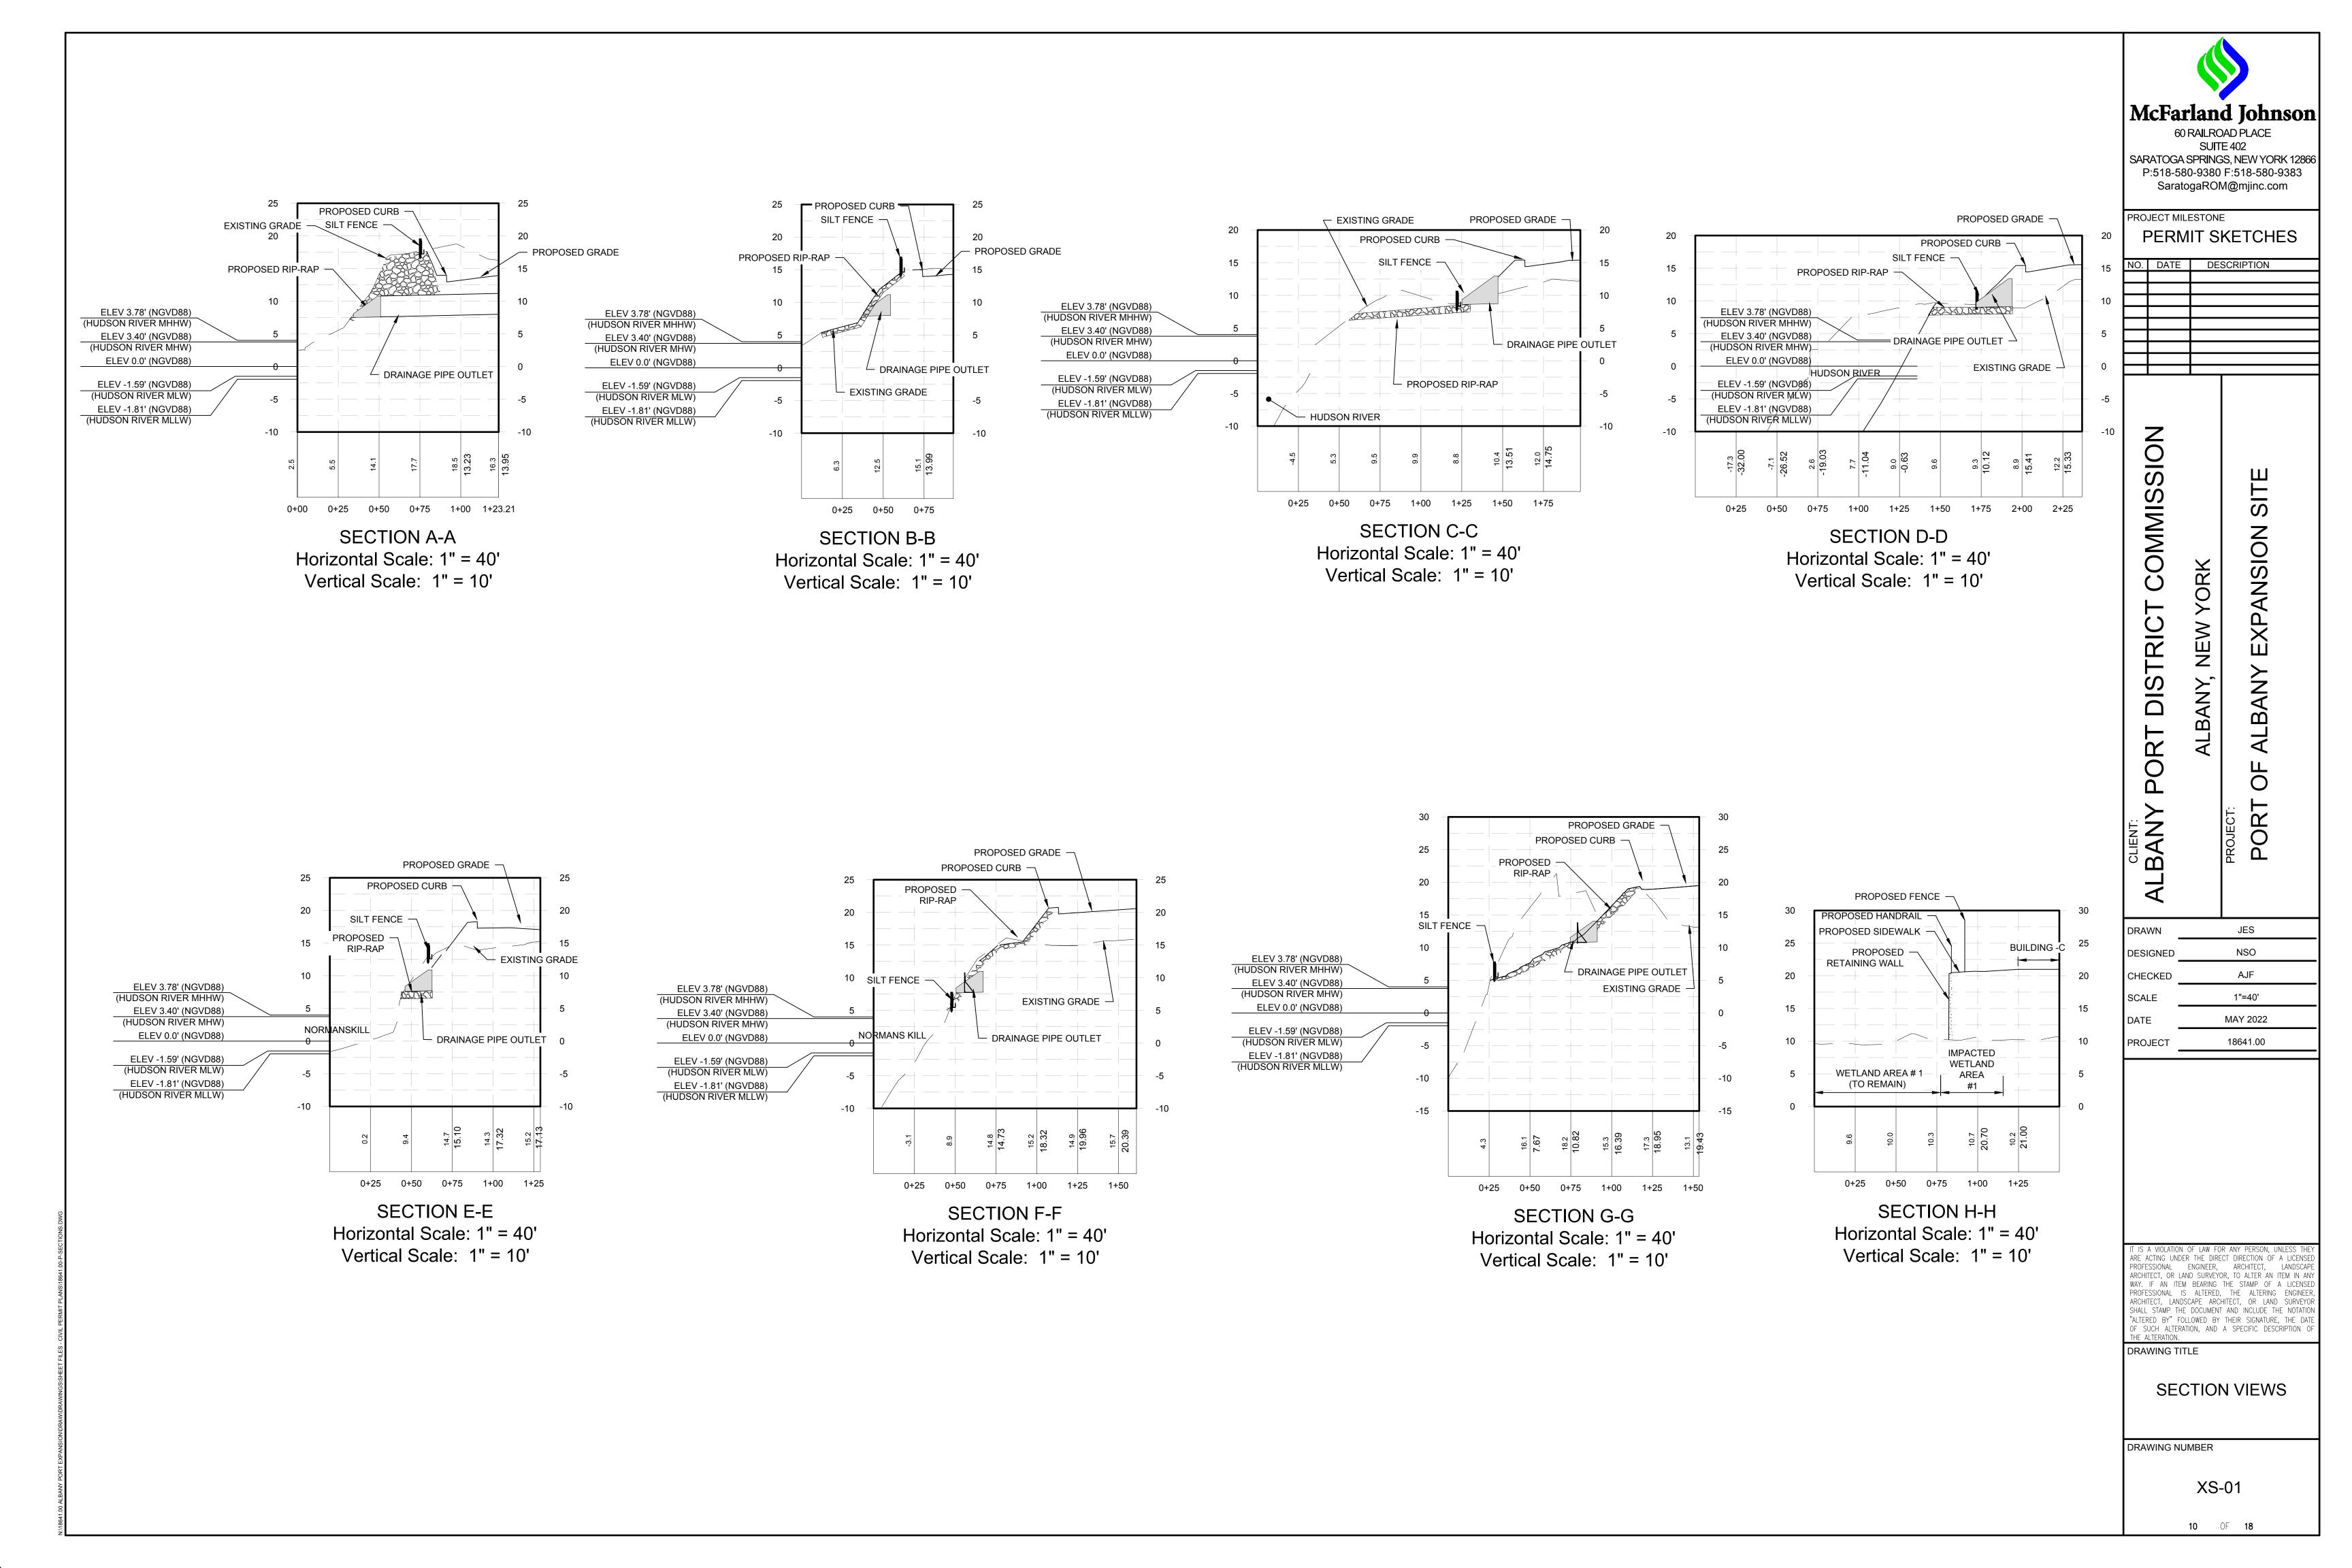

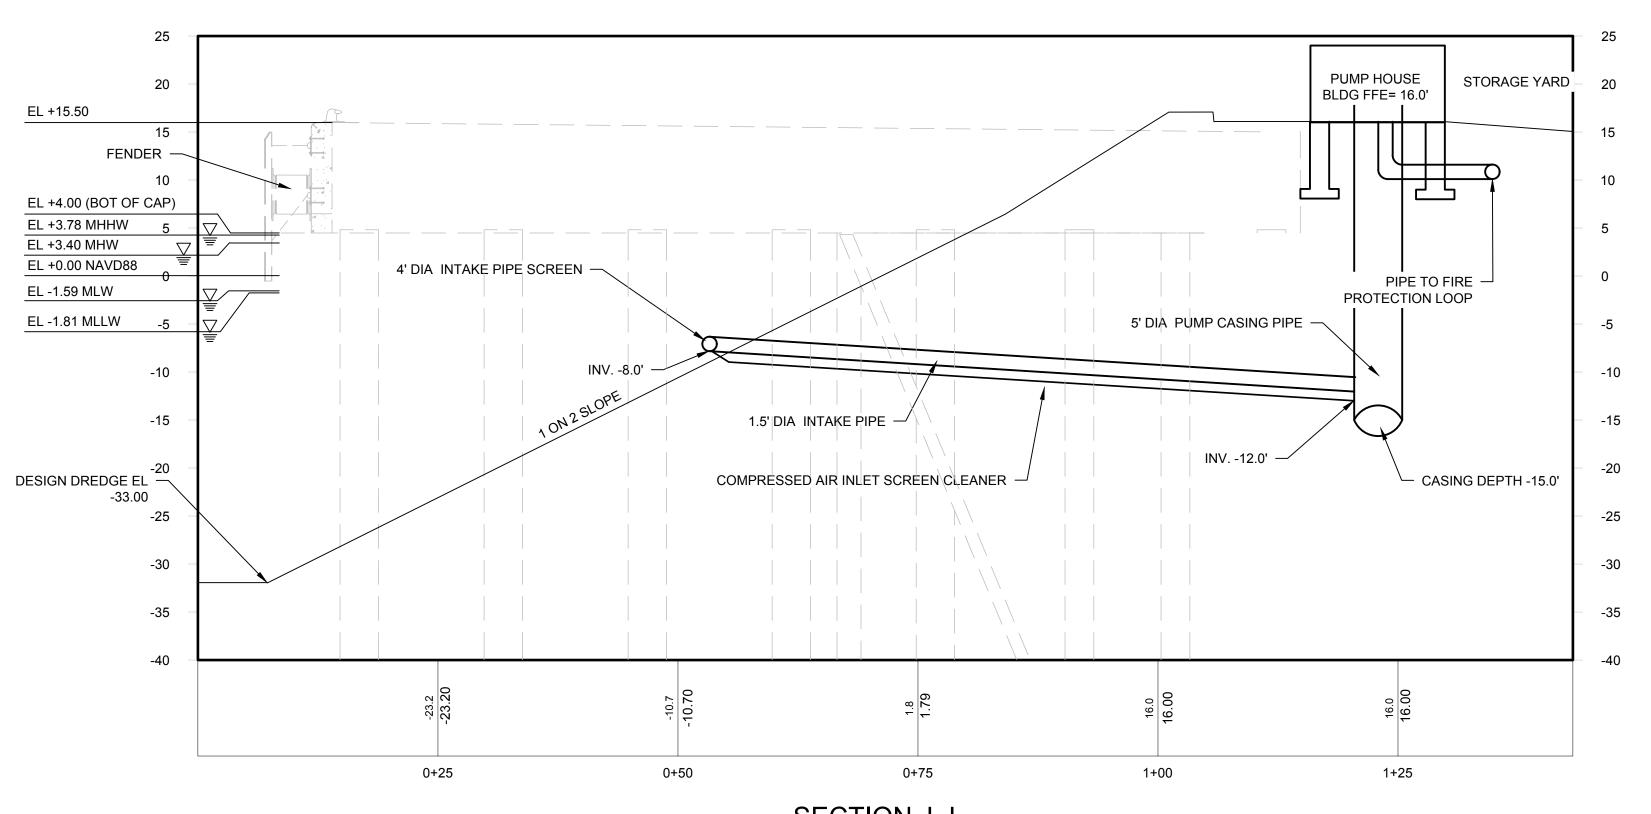

SECTION J-J Horizontal Scale: 1" = 10' Vertical Scale: 1" = 10'

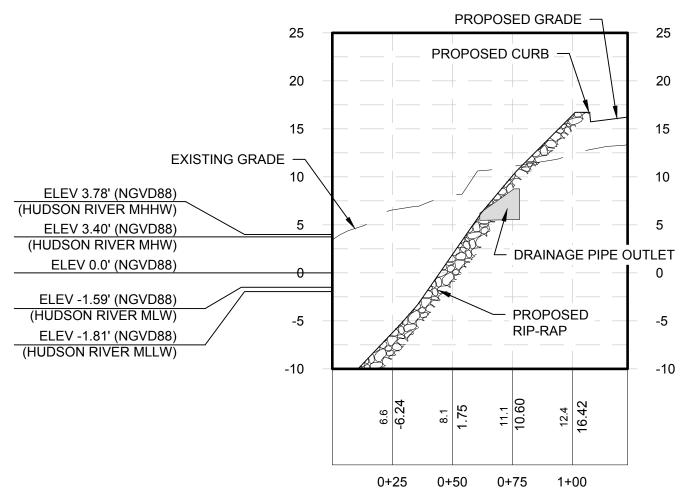

WASTE WATER TREATMENT PLANT OUTFALL (K-K)

Horizontal Scale: 1" = 40' Vertical Scale: 1" = 10' McFarland Johnson

60 RAILROAD PLACE
SUITE 402
SARATOGA SPRINGS, NEW YORK 12866
P:518-580-9380 F:518-580-9383
SaratogaROM@mjinc.com

PROJECT MILESTONE

PERMIT SKETCHES

NO.	DATE	DESCRIPTION

ALBANY PORT DISTRICT COMMISSION ALBANY, NEW YORK

DRAWN JES

DESIGNED NSO

CHECKED AJF

SCALE 1"=40'

DATE MAY 2022

PROJECT 18641.00

POR

IT IS A VIOLATION OF LAW FOR ANY PERSON, UNLESS THEY ARE ACTING UNDER THE DIRECT DIRECTION OF A LICENSED PROFESSIONAL ENGINEER, ARCHITECT, LANDSCAPE ARCHITECT, OR LAND SURVEYOR, TO ALTER AN ITEM IN ANY WAY. IF AN ITEM BEARING THE STAMP OF A LICENSED PROFESSIONAL IS ALTERED, THE ALTERING ENGINEER, ARCHITECT, LANDSCAPE ARCHITECT, OR LAND SURVEYOR SHALL STAMP THE DOCUMENT AND INCLUDE THE NOTATION "ALTERED BY" FOLLOWED BY THEIR SIGNATURE, THE DATE OF SUCH ALTERATION, AND A SPECIFIC DESCRIPTION OF THE ALTERATION.


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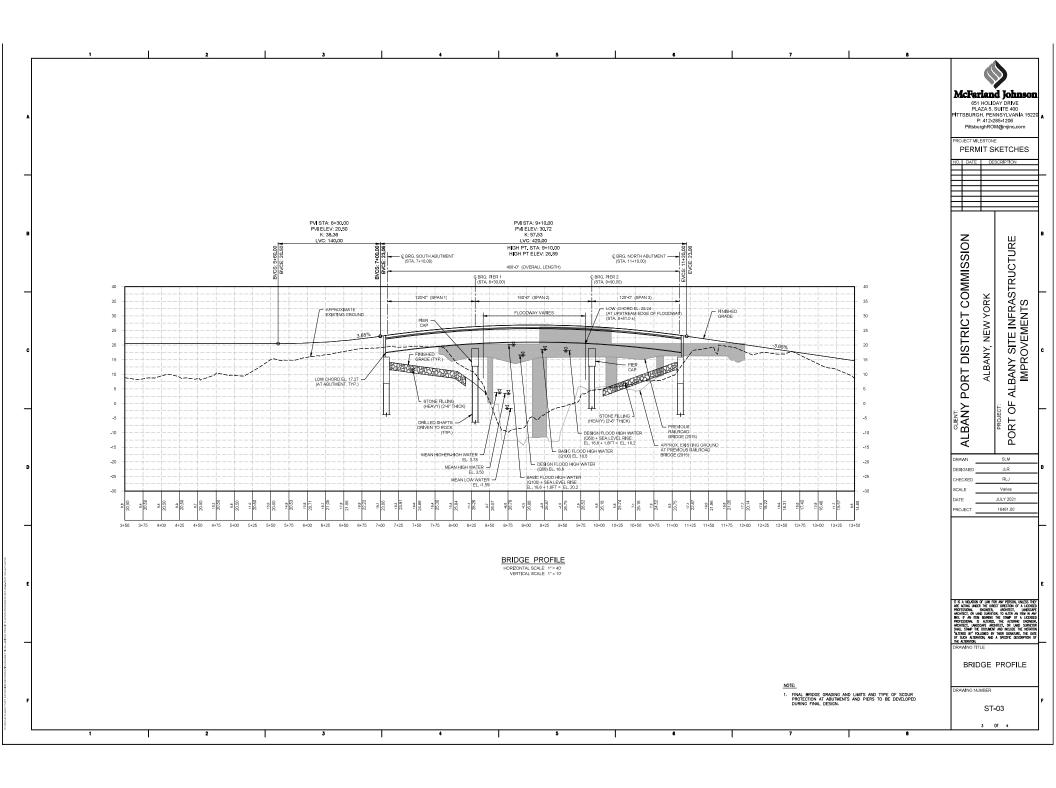
SECTION VIEWS


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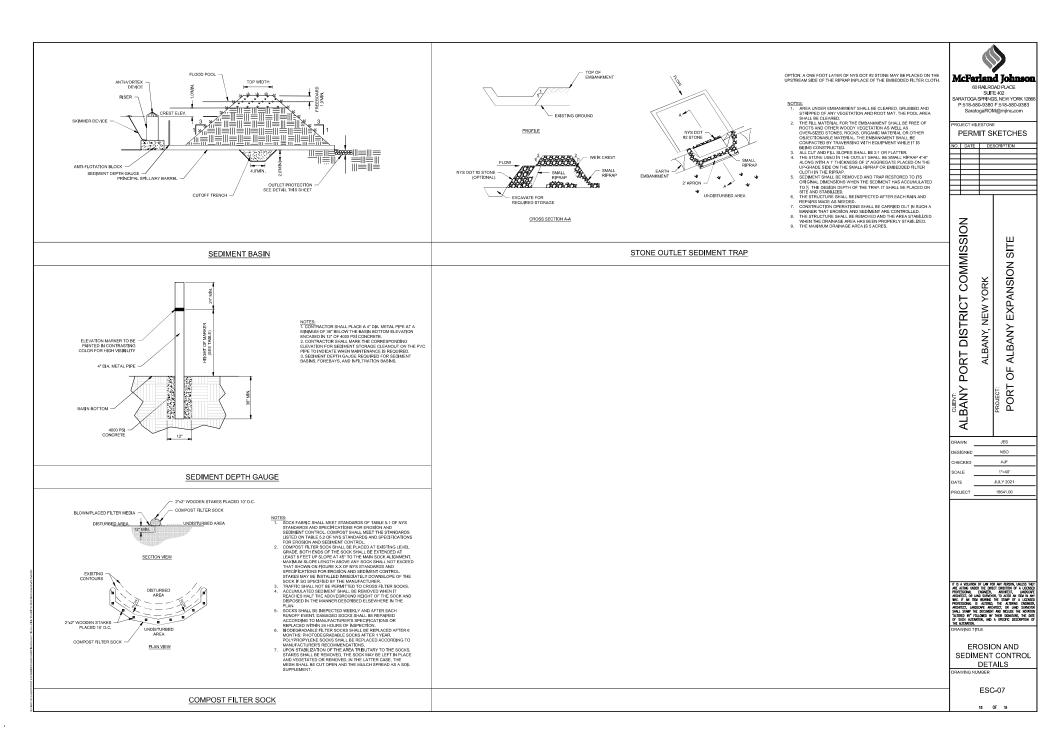
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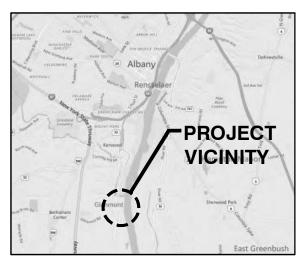
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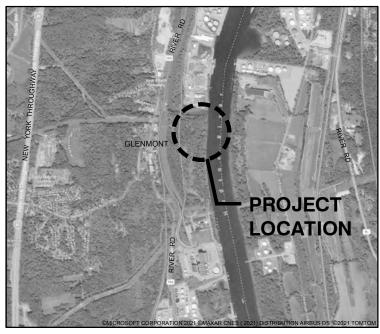








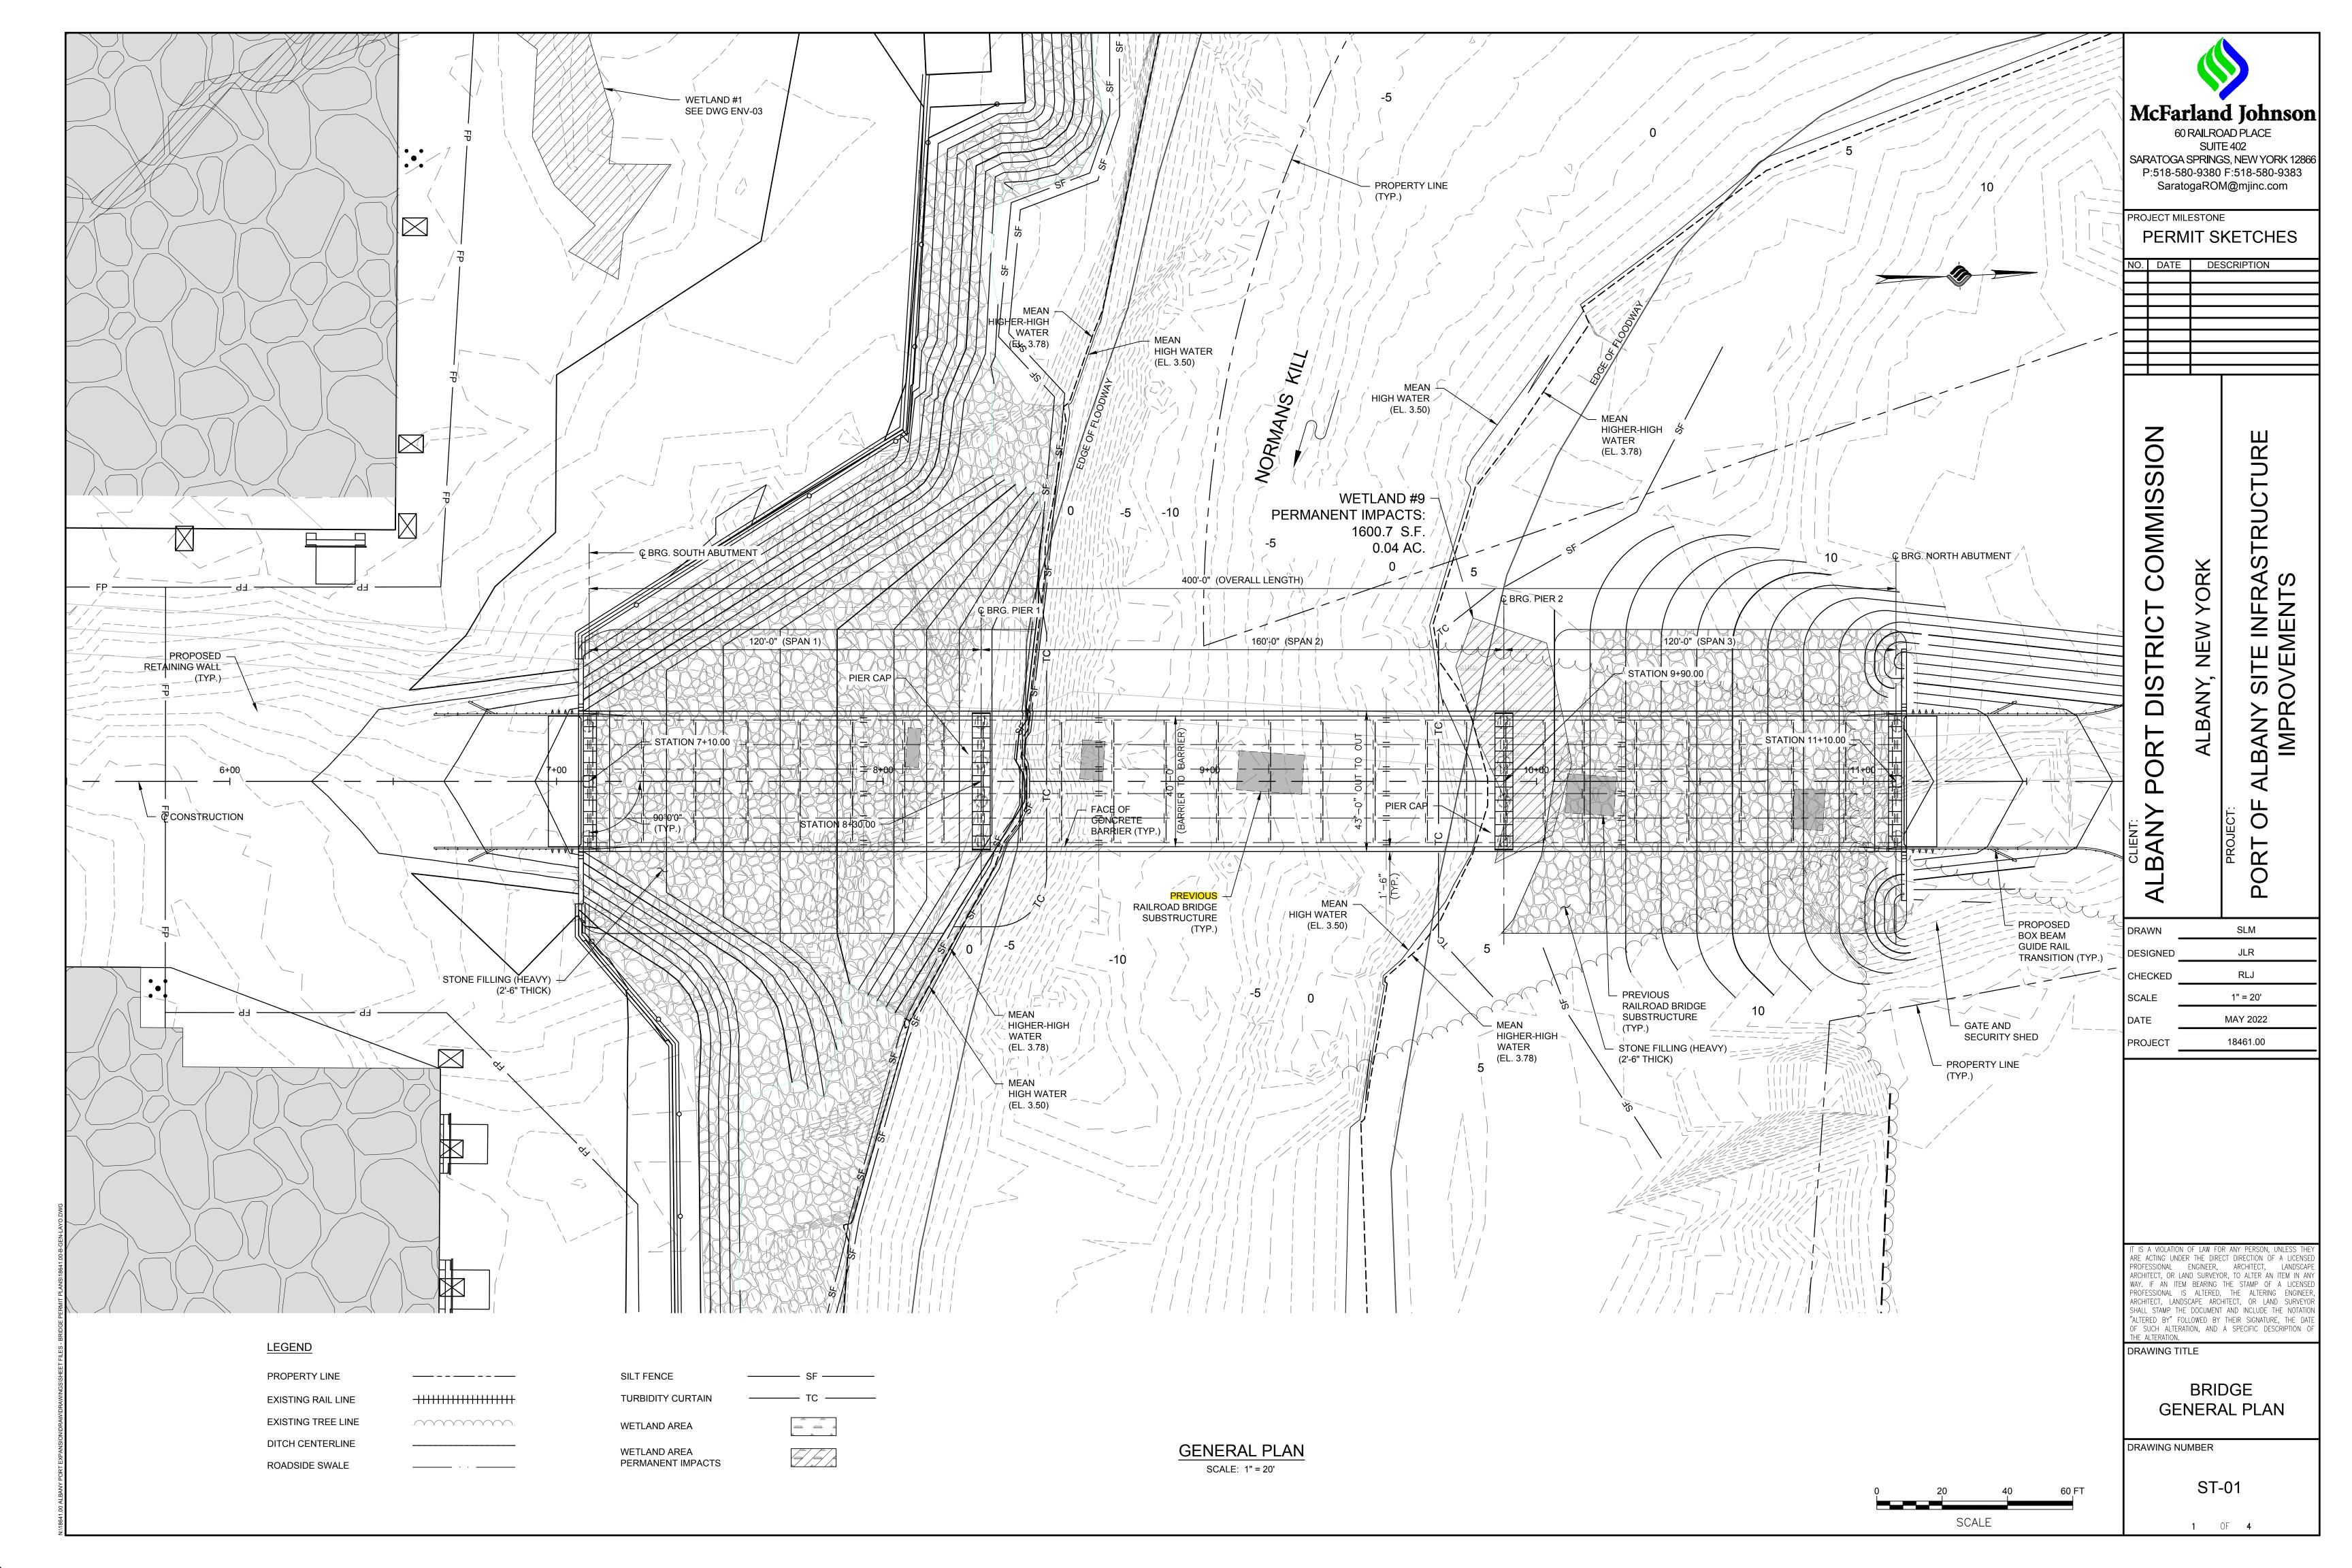

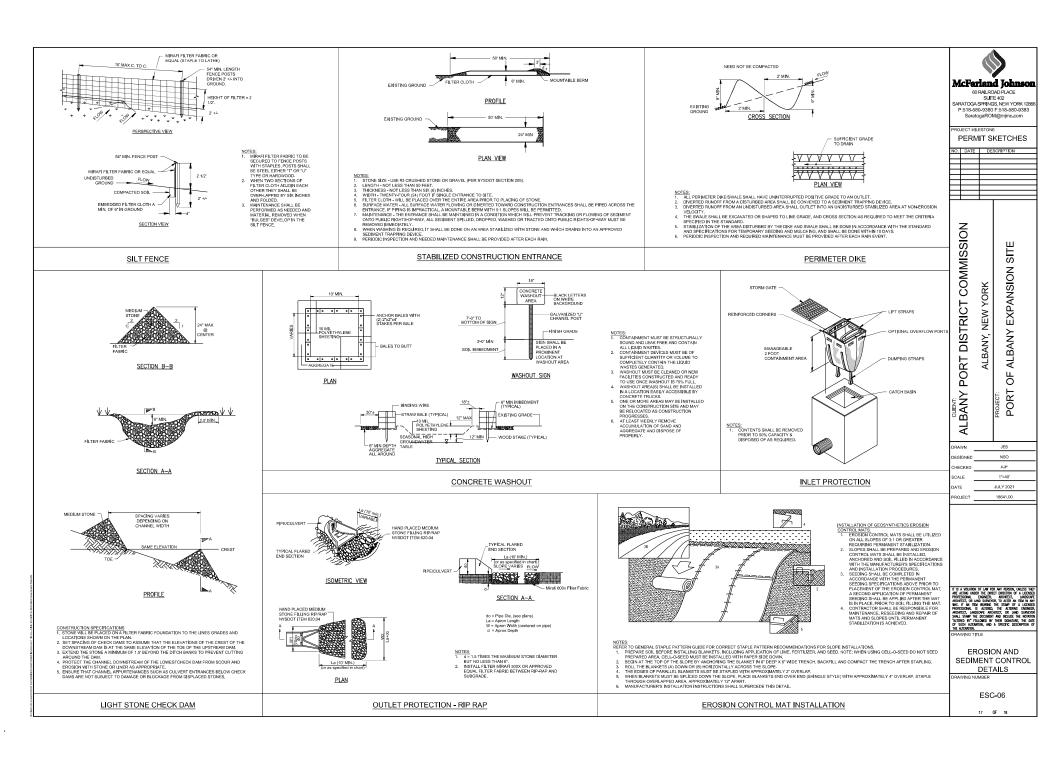



VICINITY AND LOCATION MAP SCALE: N.T.S.

NOTES:

- HORIZONTAL CONTROL REFERENCED TO NORTH AMERICAN DATUM OF 1983, STATE PLANE COORDINATE SYSTEM, NEW YORK, EAST ZONE, IN FEET.
- WATER LEVEL DATUM IS BASED ON NATIONAL GEODETIC VERTICAL DATUM OF 1929, AS FOLLOWS:
- MEAN HIGHER HIGH WATER LEVEL (MHHW) +4.56 FT (NGVD29)
- MEAN HIGH WATER LEVEL (MHW) = +4.18 FT (NGVD29)
- MEAN TIDE LEVEL (MTL) = +1.69 FT (NGVD29)
- MEAN LOW WATER LEVEL (MLW) = -0.80 FT (NGVD29)

PURPOSE: WHARF CONSTRUCTION PERMIT SUBMITTAL-NOT TO BE USED FOR CONSTRUCTION DATUM: NGVD29



m&n engineering, p.c.

OWNER/APPLICANT: ALBANY PORT DISTRICT COMMISSION PORT OF ALBANY

IN: NEAR:

LOCATION:

HUDSON RIVER SOUTH OF ALBANY PORT OF ALBANY

106 SMITH BOULEVARD ALBANY, NEW YORK 12202 WHARF DREDGING AND CONSTRUCTION

VICINITY AND LOCATION

DATE: 2021-07-15

PLAN - EXISTING CONDITIONS



PURPOSE: WHARF CONSTRUCTION PERMIT SUBMITTAL-NOT TO BE USED FOR CONSTRUCTION DATUM: NGVD29

7/14/2021 3:22 PM by MWILKINSON

Permits11094901P-02; Plotted: 7/15/2021 8:44 AM by WILKINSON, MELISSA; Saved:

Q:INY110949-01120



m&n engineering, p.c.

OWNER/APPLICANT: ALBANY PORT DISTRICT COMMISSION

PORT OF ALBANY
IN: HUDSON RIVER
NEAR: SOUTH OF ALBA

NEAR: SOUTH OF ALBANY
LOCATION: PORT OF ALBANY
106 SMITH BOULEVARD
ALBANY, NEW YORK 12202

WHARF DREDGING AND CONSTRUCTION

PLAN - EXISTING CONDITIONS

DATE: 2021-07-15

